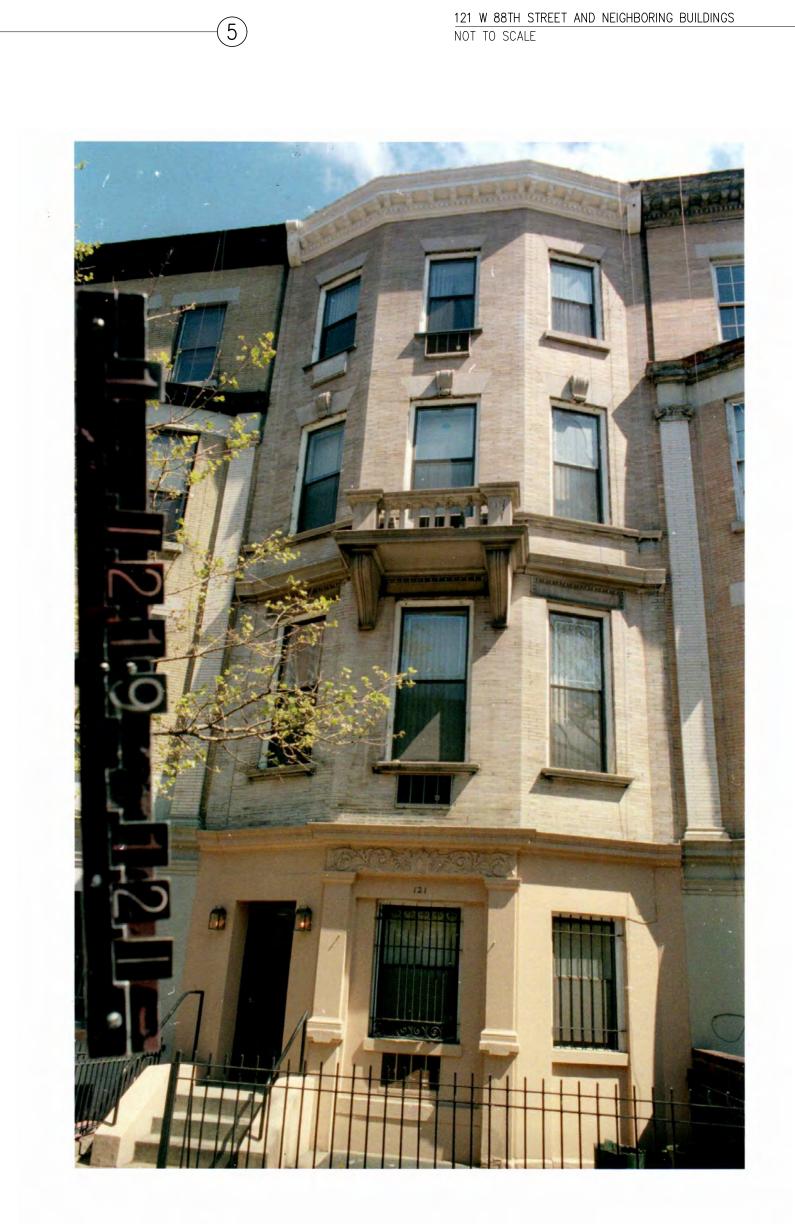
WEST SOFIL STREET

PARK



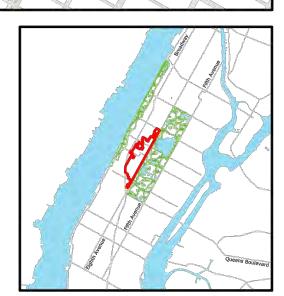
BLOCK PLAN NOT TO SCALE

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DATE ISSUE

10.17.18 DOB REVIEW

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PROJECT:

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TAX ID PHOTO, HISTORIC DISTRICT MAP & FRONT PHOTO



DATE: 10/05/1
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DRAWING BY: YW
CHK BY: DO
DWG No:

LPC101.00

HISTORIC DISTRICT MAP
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Upper West Side-Central Park West

Historic District

Manhattan

Designated April 24, 1990

Historic District Boundaries

EXISTING FRONT ELEVATION
1/4"=1'-0"

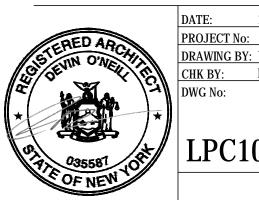
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EXISTING FRONT BUILDING ELEVATION



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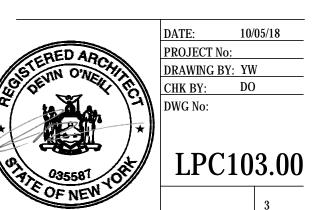
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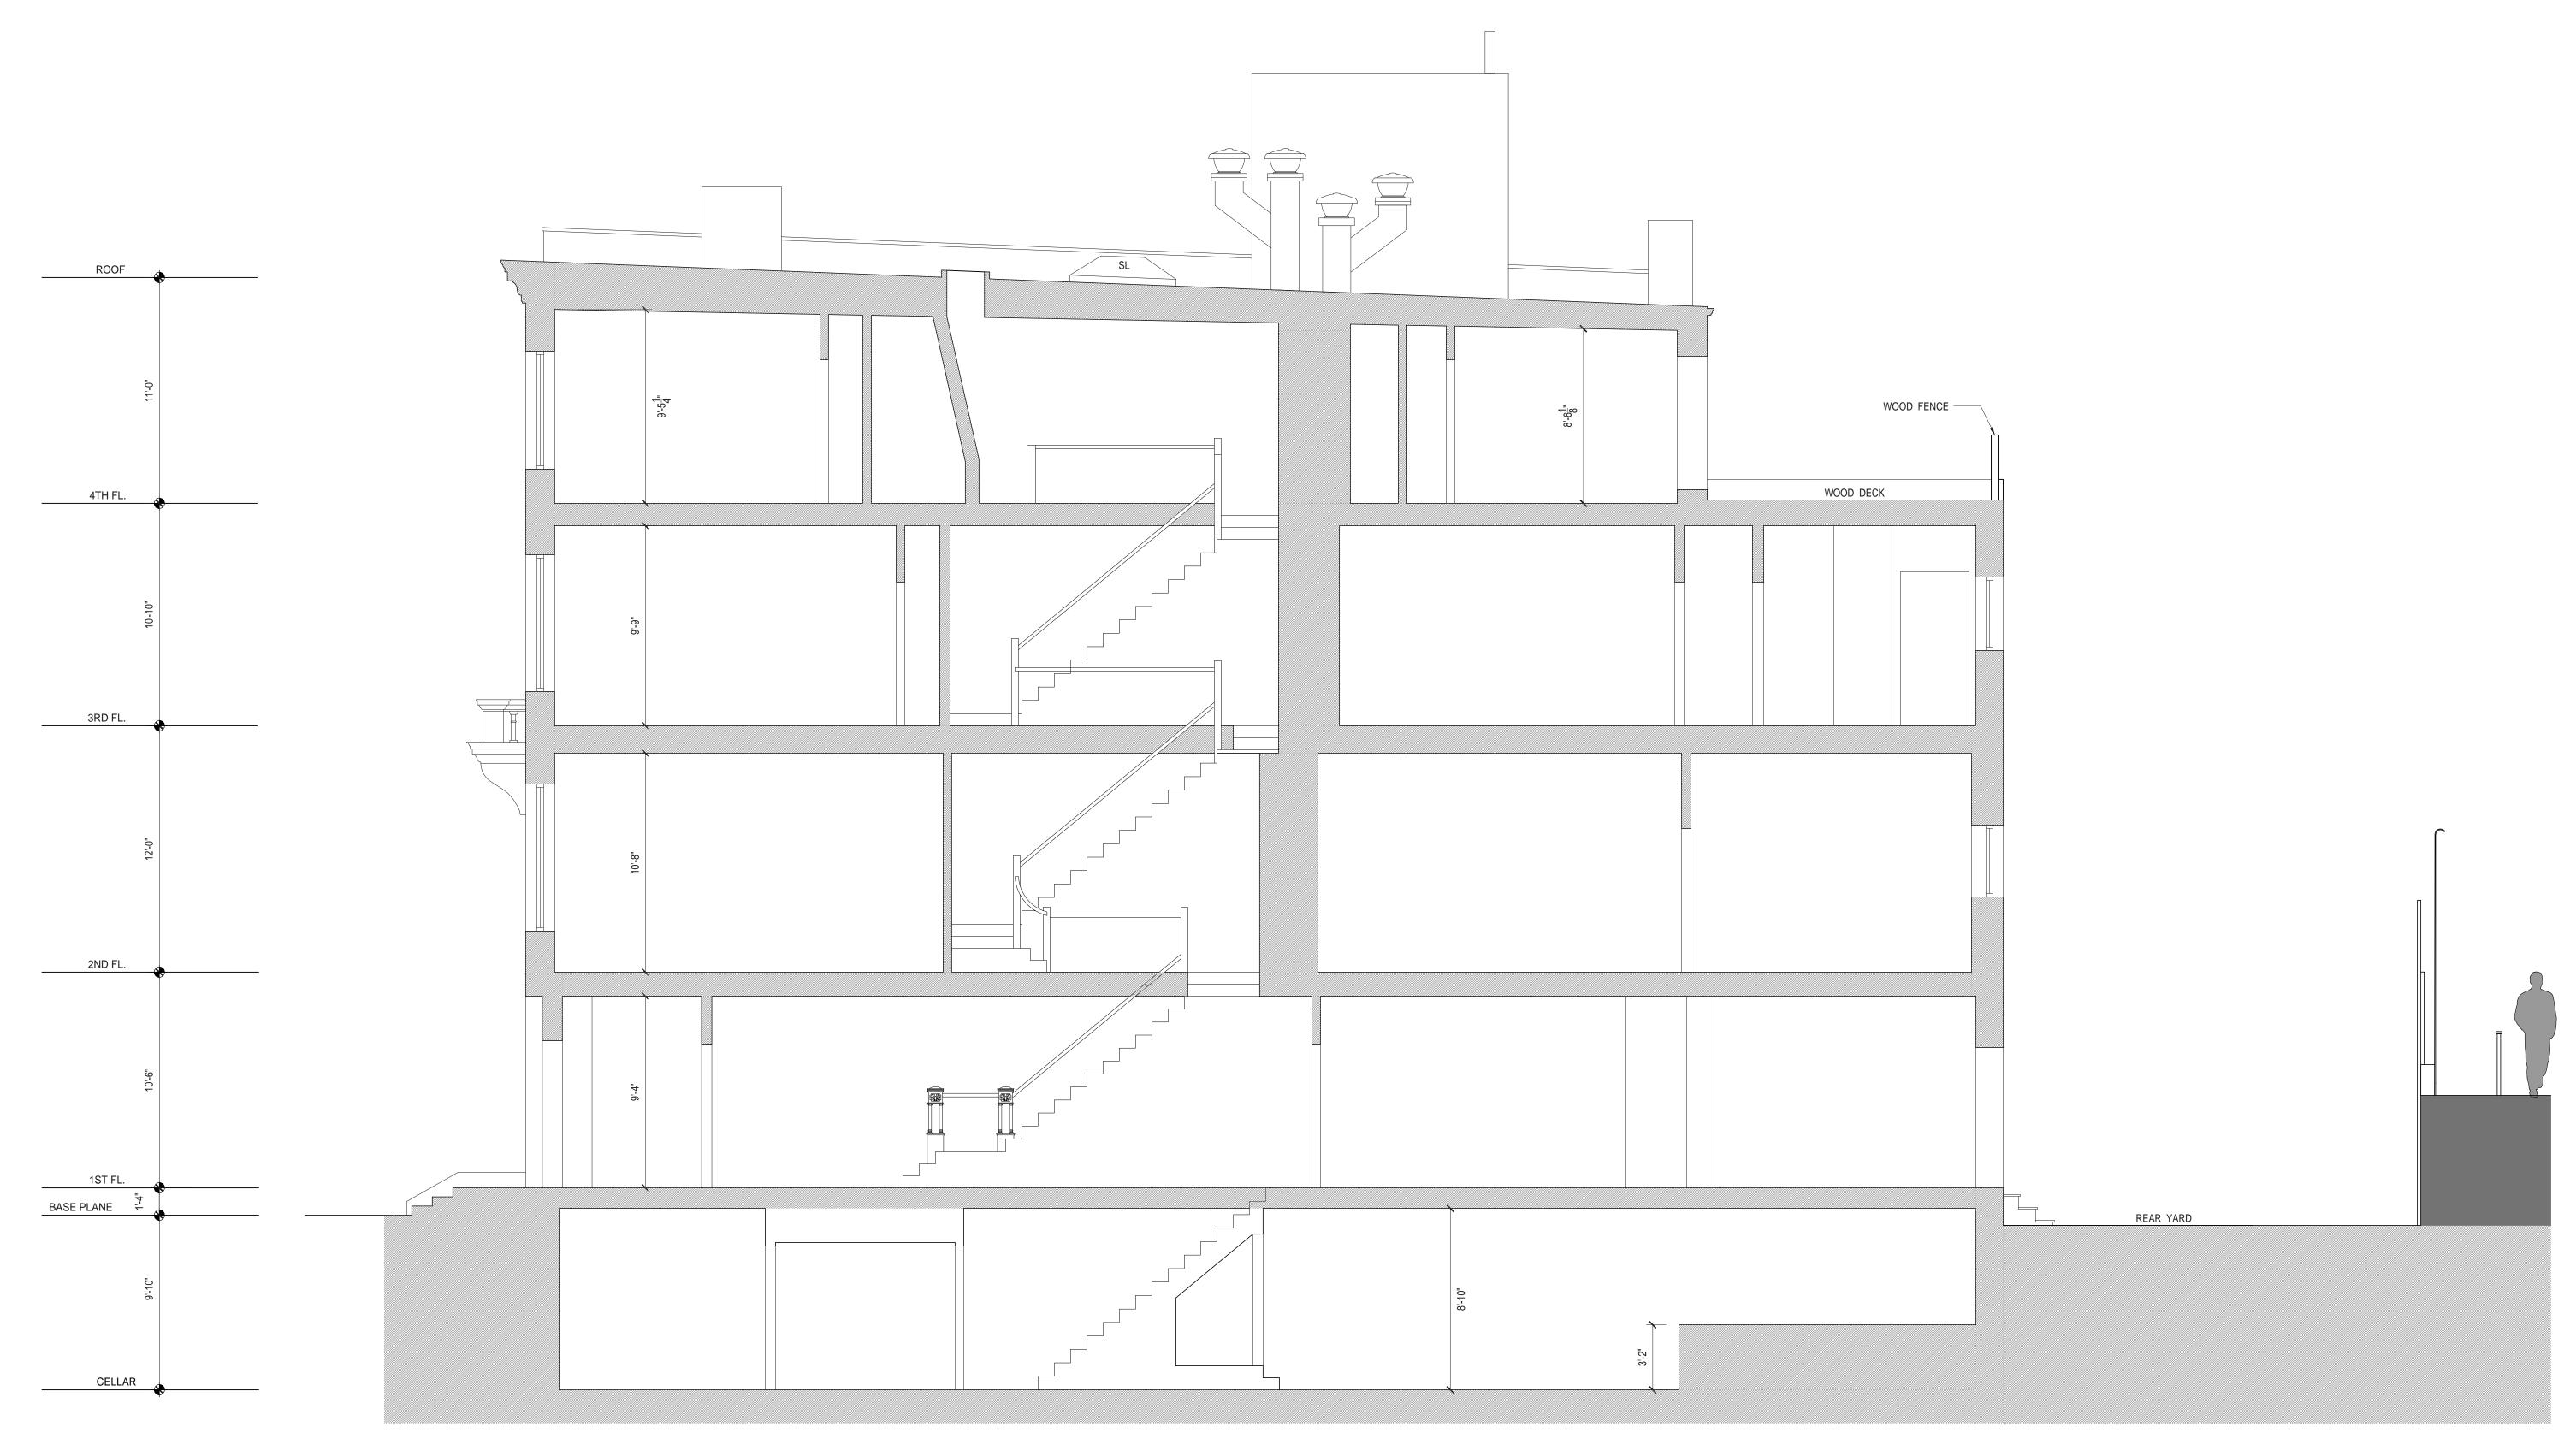
PROPOSED FRONT BUILDING ELEVATION



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PROPOSED FRONT BUILDING ELEVATION 1/4"=1'-0"

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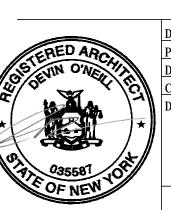
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EXISTING BUILDING SECTION



PROPOSED BUILDING SECTION
1/4"=1'-0"

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PROPOSED BUILDING SECTION

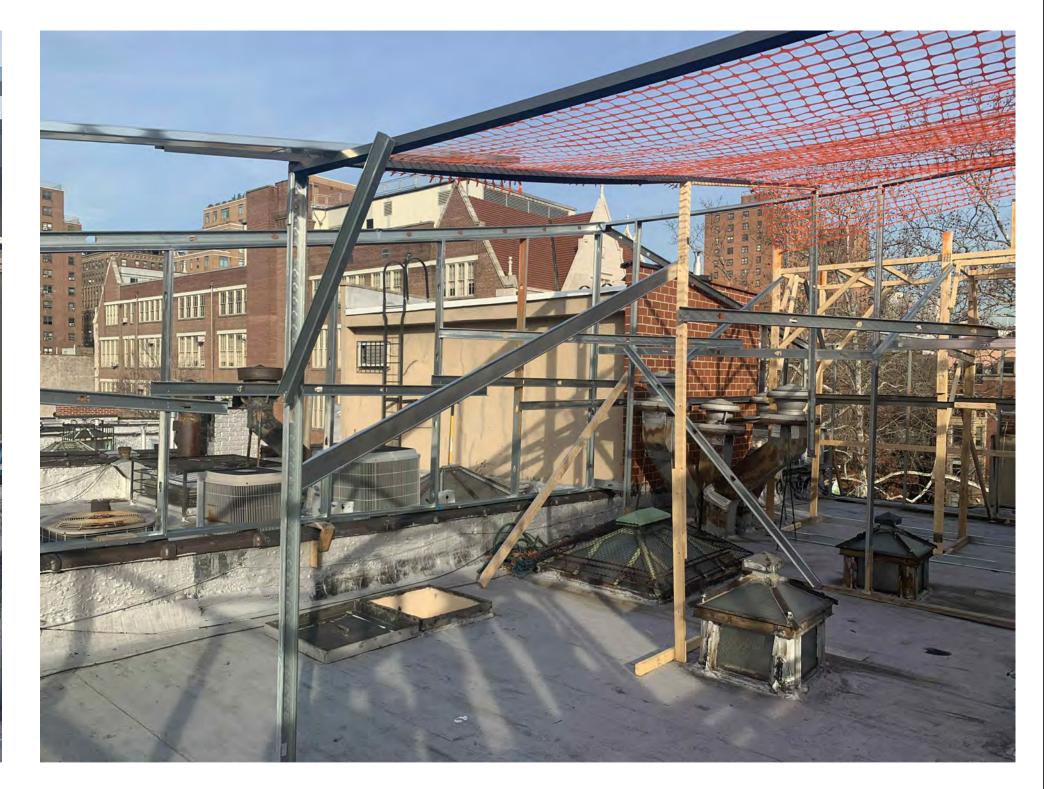


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PROPOSED SOLAR PANELS







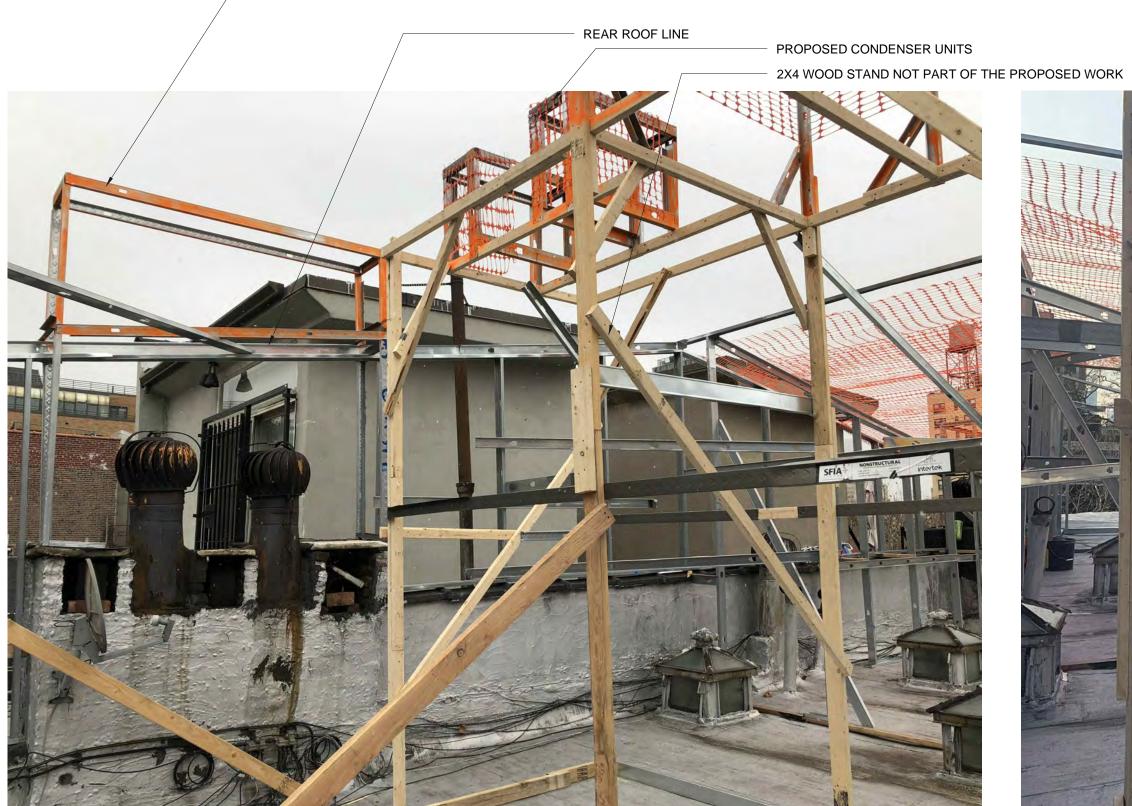
ROOF ADDITION MOCK UP
NOT TO SCALE

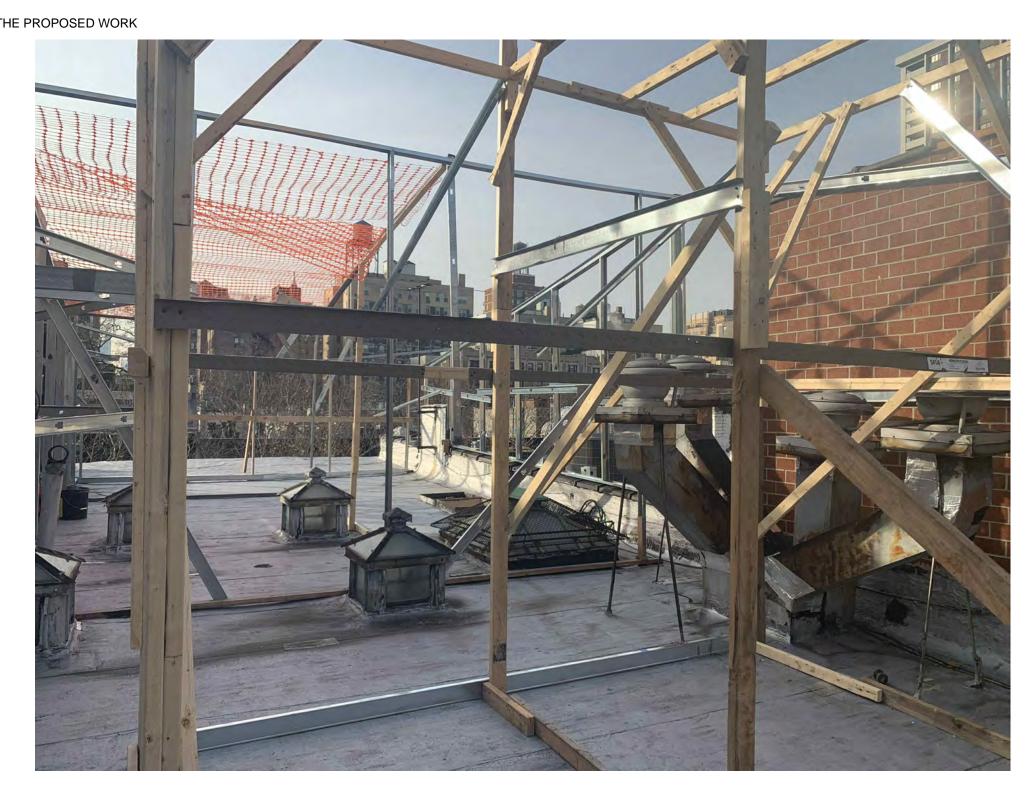
REAR CHIMNEY EXTENDED UP 3 FEET ABOVE REAR ROOF LINE

ROOF ADDITION MOCK UP
NOT TO SCALE

ROOF ADDITION MOCK UP

NOT TO SCALE





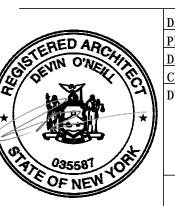
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ROOF ADDITION MOCK UP PHOTO



ROOF ADDITION MOCK UP NOT TO SCALE

ROOF ADDITION MOCK UP
NOT TO SCALE

ITION MOCK UP

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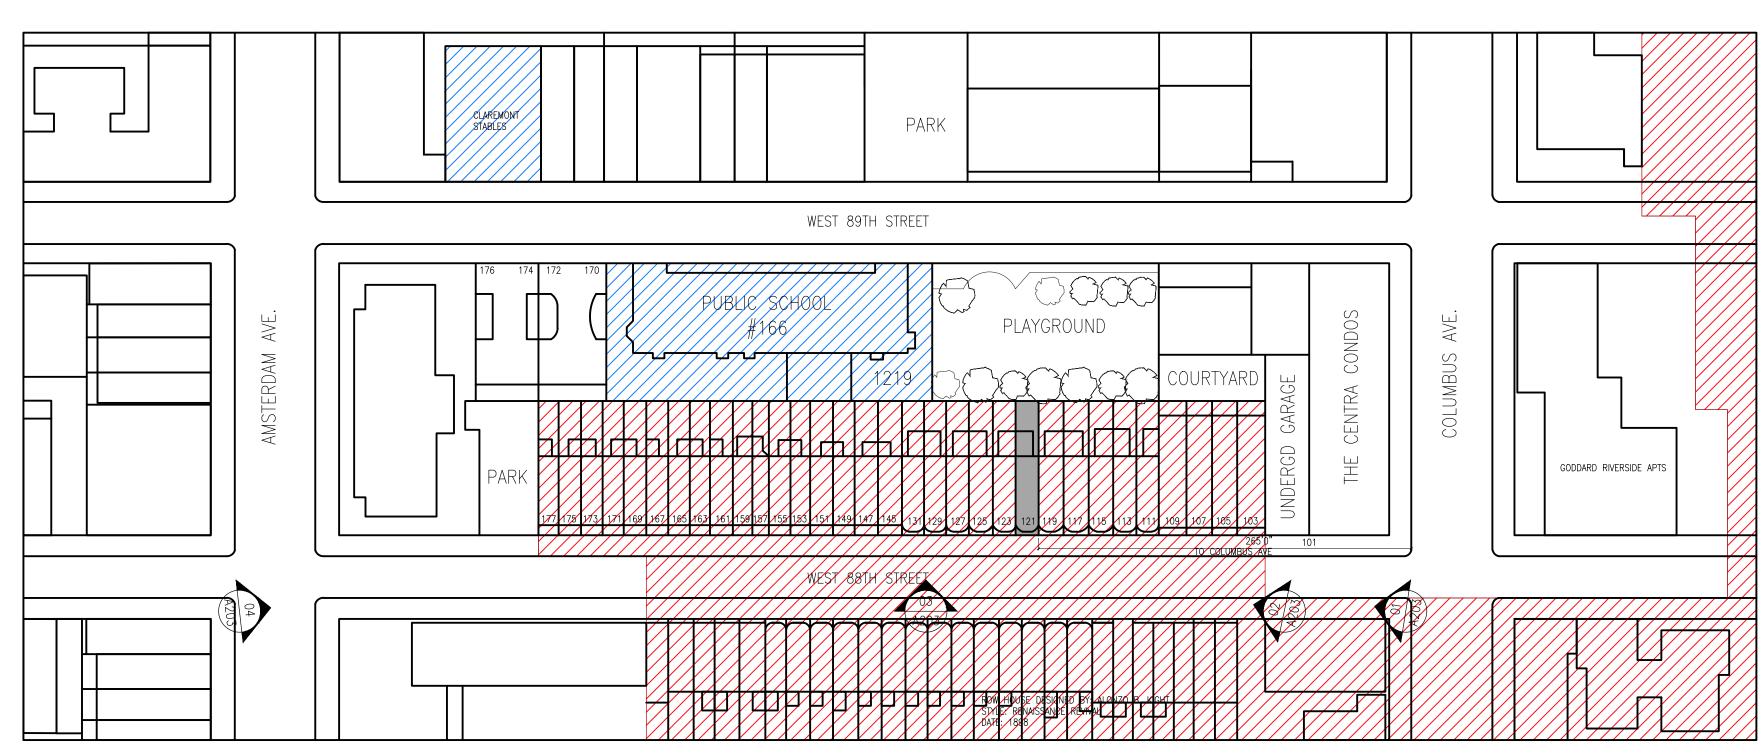


VIEW OF ADDITION ROOF MOCK UP FROM W 88TH STREET

NOT TO SCALE

VIEW OF ADDITION ROOF MOCK UP FROM W 88TH STREET
NOT TO SCALE

INDIVIDUAL LANDMARK BUILDING





VIEW OF ADDITION ROOF MOCK UP FROM W 88TH STREET
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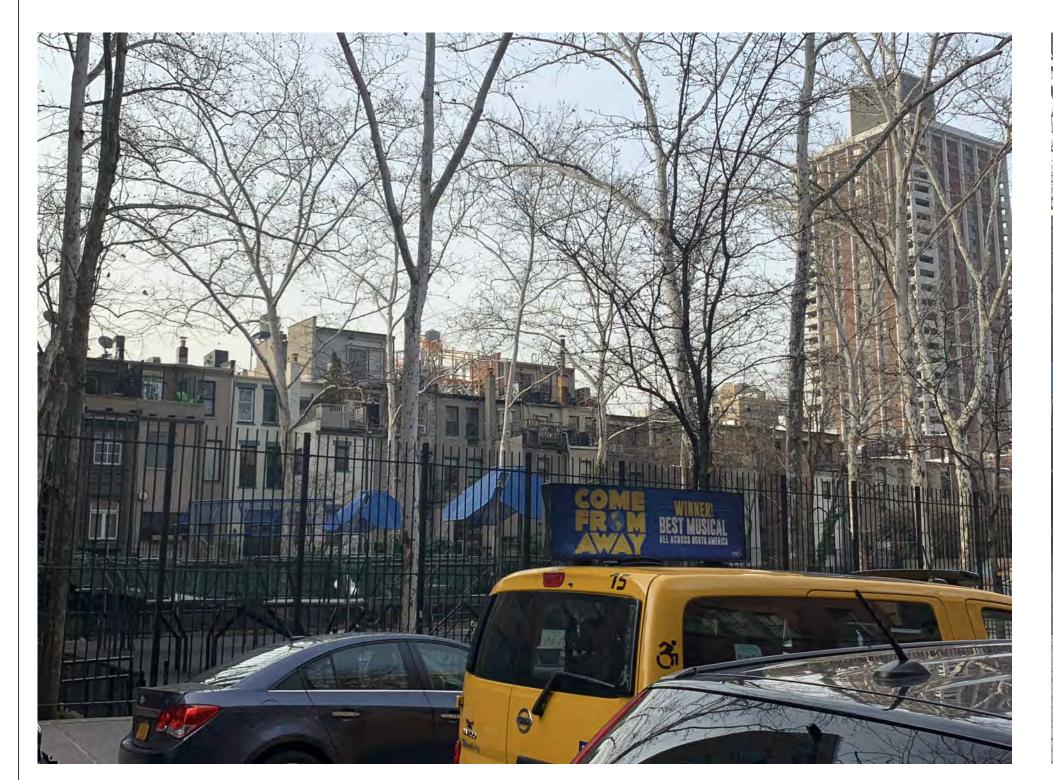
ROOF ADDITION MOCK UP PHOTO



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BLOCK PLAN NOT TO SCALE

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VIEW OF ROOF ADDITION MOCK UP FROM W 89TH STREET
NOT TO SCALE

1 VIEW OF ROOF ADDITION MOCK UP FROM W 89TH STREET NOT TO SCALE

VIEW OF ROOF ADDITION MOCK UP FROM W 89 STREET

NOT TO SCALE

DATE ISSUE

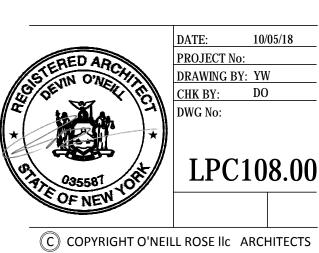
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ROOF ADDITION MOCK UP PHOTO



WEST 89TH STREET

STREET

WEST 89TH STREET

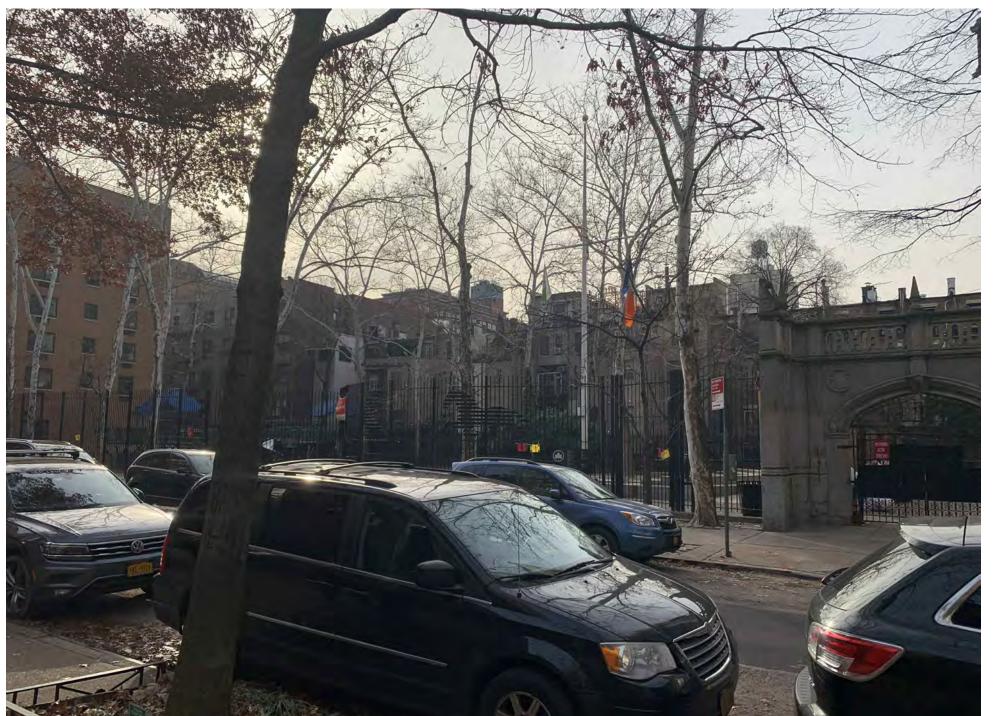
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WEST 89TH STREET

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WEST 89TH STREET

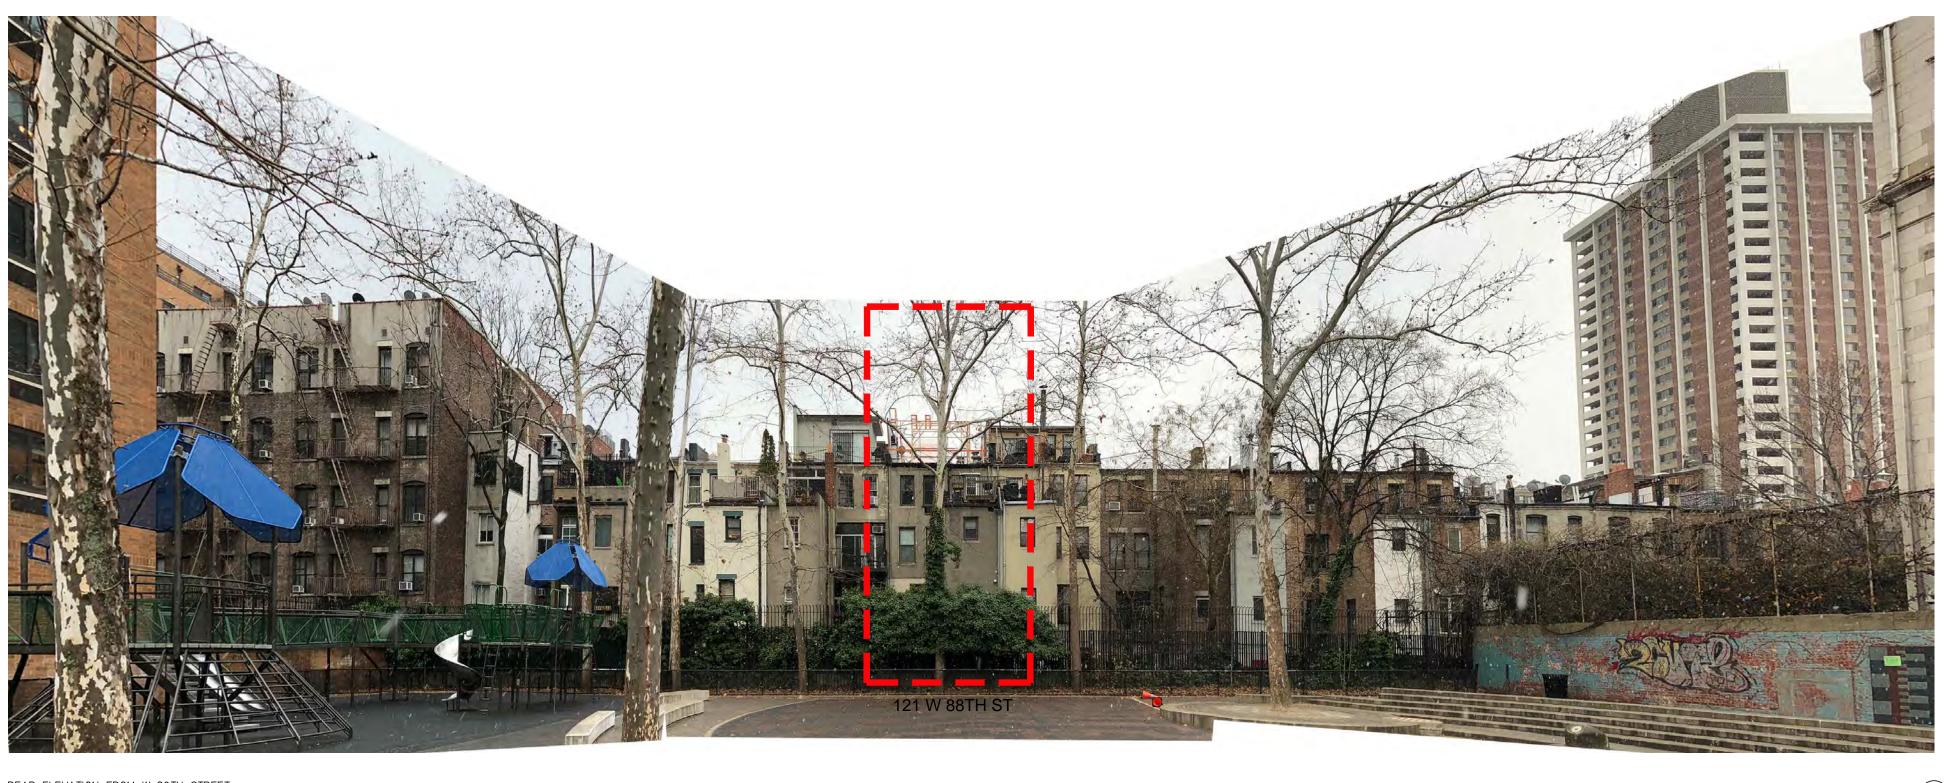
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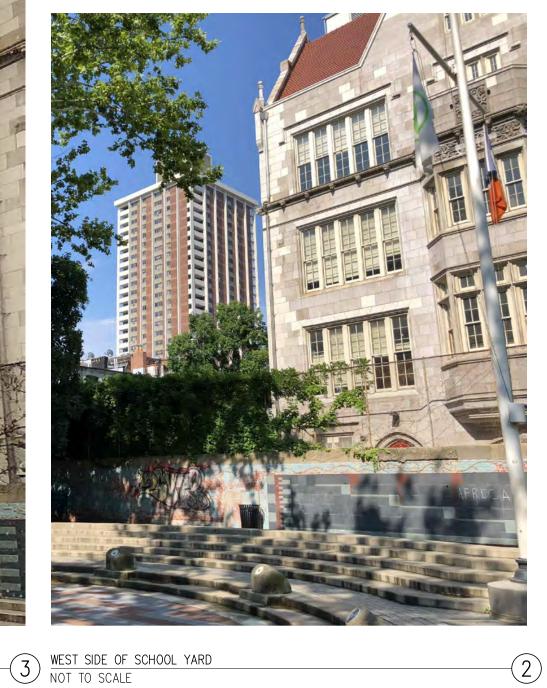


VIEW OF ROOF ADDITION MOCK UP FROM W 89TH STREET
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EAST SIDE OF SCHOOL YARD NOT TO SCALE REAR ELEVATION FROM W 89TH STREET NOT TO SCALE

BLOCK BUILDING HEIGHT DIAGRAM

NOT TO SCALE

NUMBER OF STORIES REAR ADDITION STORIES GROUND LEVEL 3 STORIES 4 STORIES 4 STORIES 5 STORIES WEST 88TH STREET > 7 STORIES COLUMBUS PARK COURT YARD PLAYGROUND THE CENTRA CONDOS PUBLIC SCHOOL NO.166 WEST 89TH STREET

DATE ISSUE

DATE ISSUE

PROJECT:

121 WEST 88TH STREET NEW YORK, NY 10024

EXISTING REAR ELEVATION & BLOCK PLAN

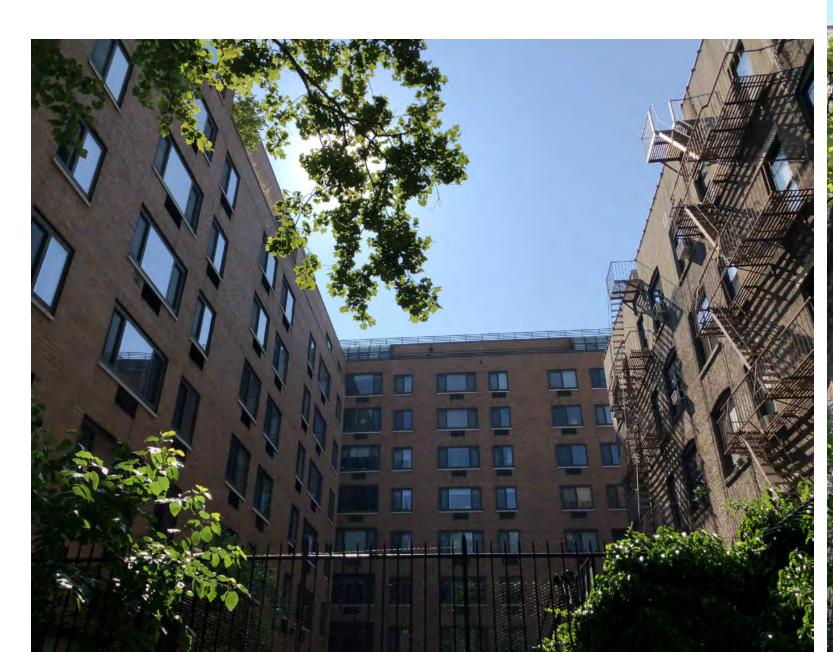
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DWG No:

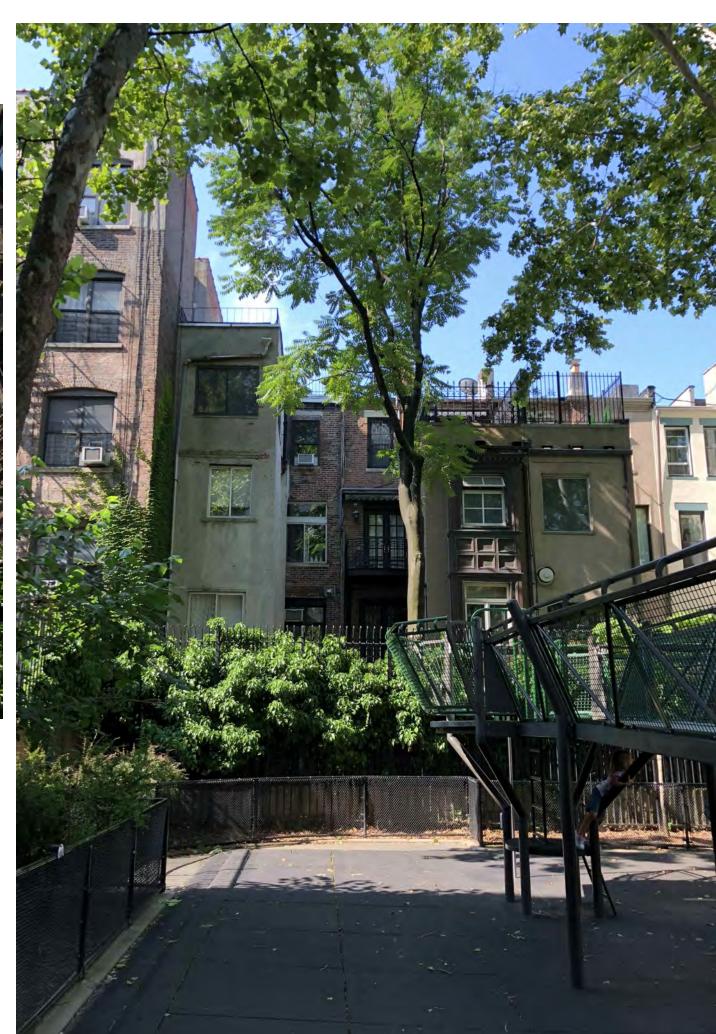
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VIEW OF BUILDING REAR FACADES WITHIN THE ROW

NOT TO SCALE

VIEW OF BUILDING REAR FACADES WITHIN THE ROW

NOT TO SCALE

3 VIEW OF BUILDING REAR FACADES WITHIN THE ROW NOT TO SCALE

VIEW OF BUILDING REAR FACADES WITHIN THE ROW NOT TO SCALE

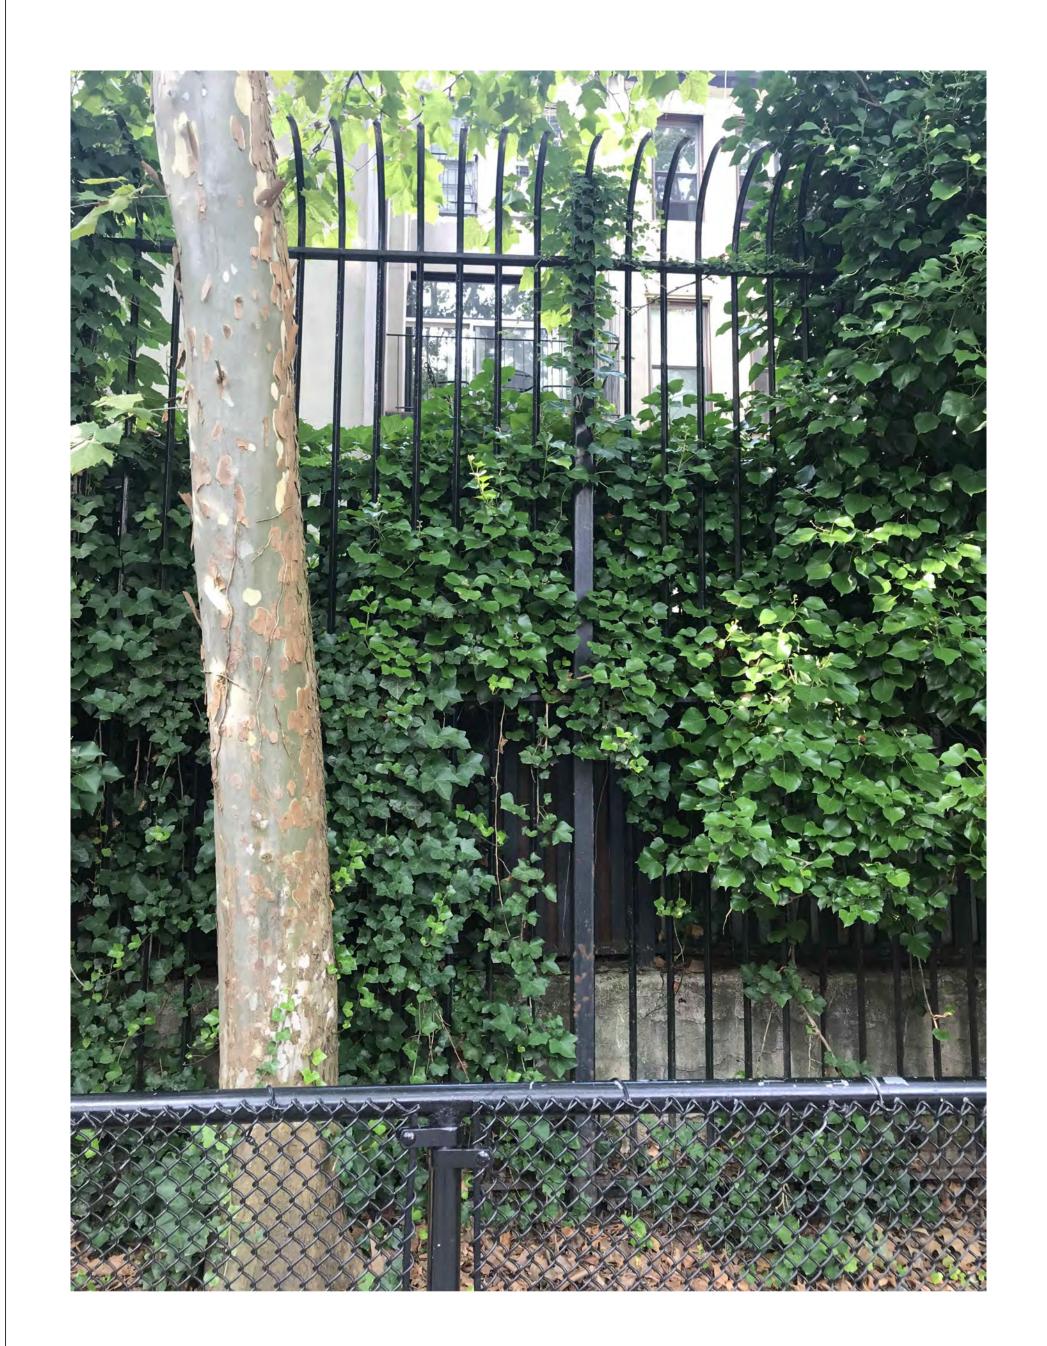
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PROJECT No:
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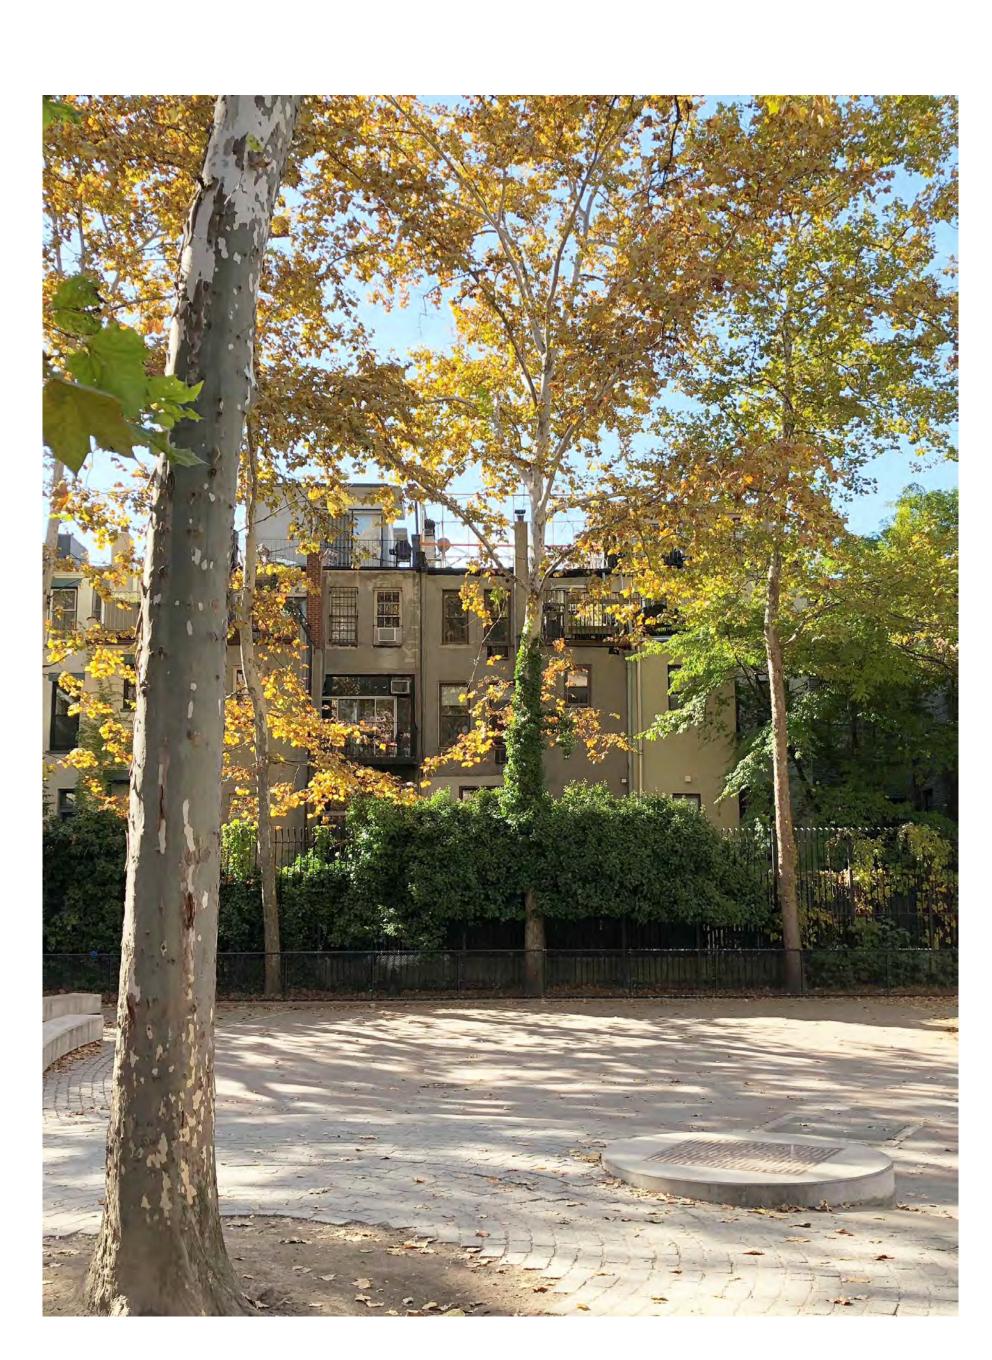
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SCHOOL YARD FENCE DETAIL NOT TO SCALE



SCHOOL YARD FENCE DETAIL NOT TO SCALE



SCHOOL YARD FENCE DETAIL

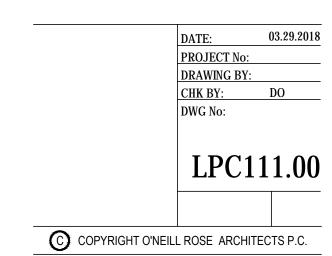
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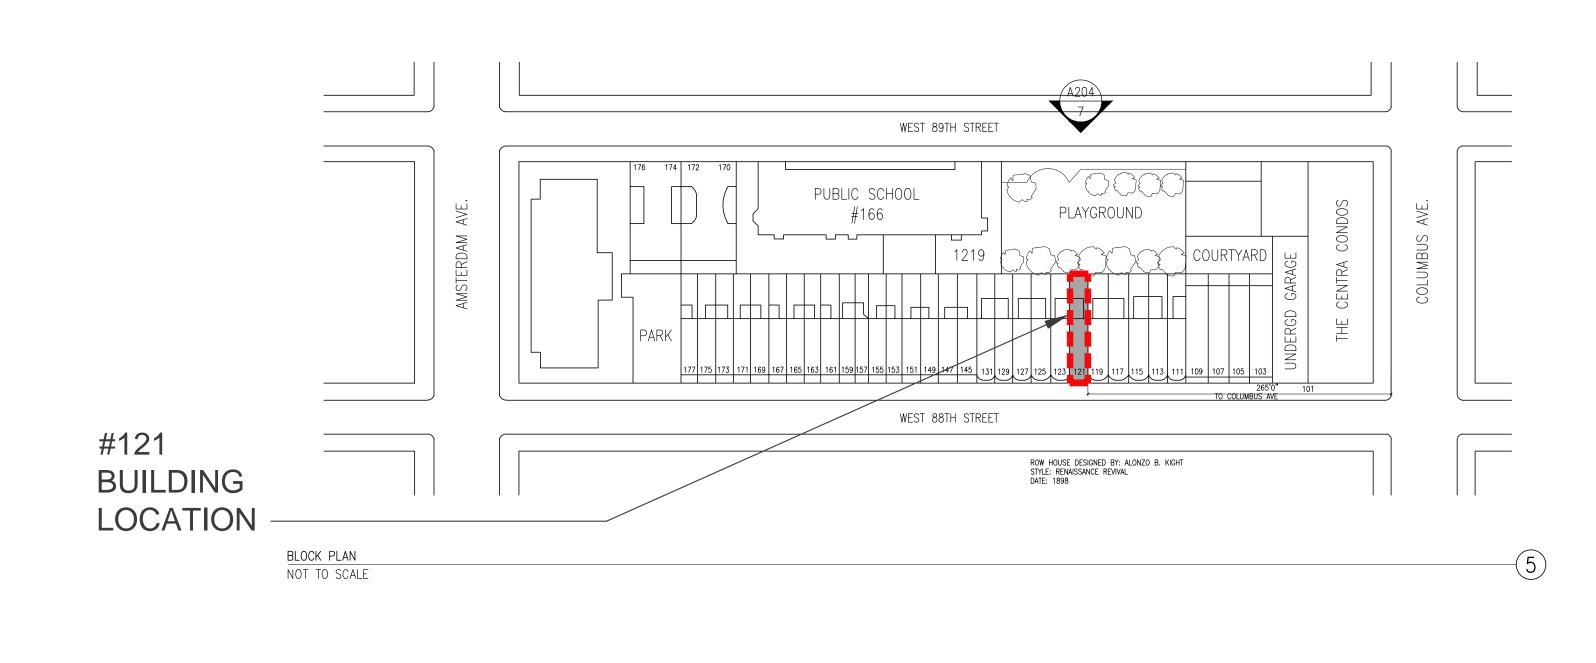
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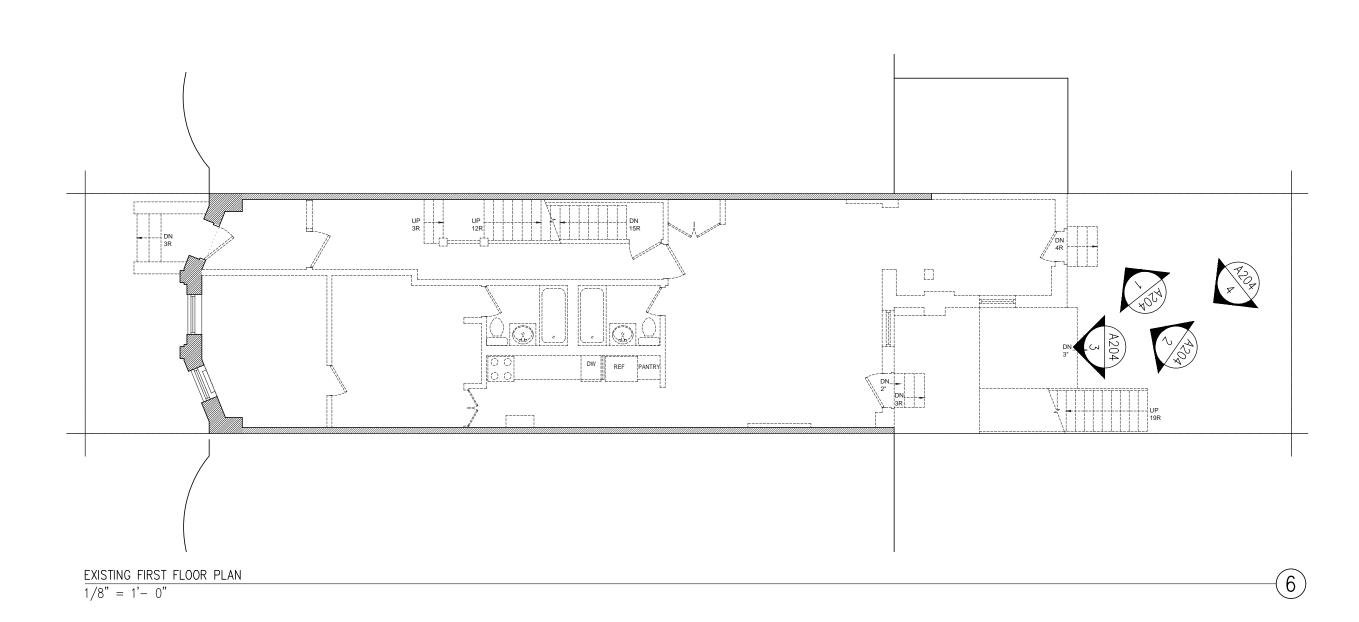
121 WEST 88TH STREET NEW YORK, NY 10024

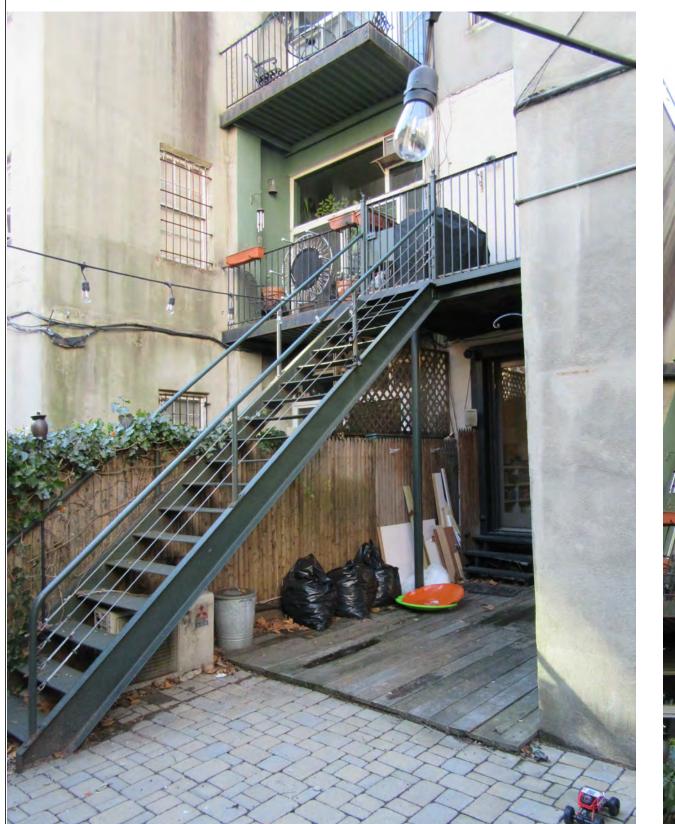
SCHOOL YARD FENCE DETAIL



# EXISTING PAINTED SHEET METAL RECTANGULAR CORNICE TO BE REPLICATED







VIEW FROM REAR YARD — CLOSE UP NOT TO SCALE







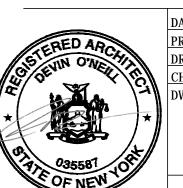
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VIEW OF EXISTING REAR BUILDING ELEVATION



DWG No:

LPC112.0

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VIEW FROM REAR YARD

NOT TO SCALE

VIEW FROM REAR YARD

NOT TO SCALE

VIEW FROM REAR YARD
NOT TO SCALE

VIEW FROM REAR YARD NOT TO SCALE



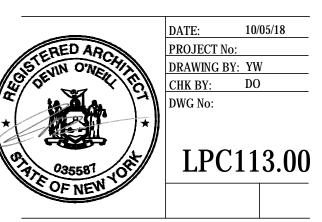
EXISTING REAR BUILDING ELEVATION 1/4"=1'-0"

ISSUES AND REVISIONS 10.17.18 DOB REVIEW

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EXISTING REAR BUILDING ELEVATION



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PROPOSED REAR BUILDING ELEVATION 1/4"=1'-0"

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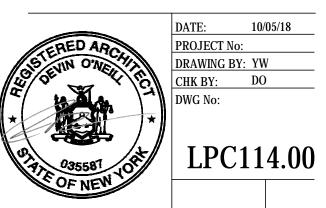
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PROPOSED REAR BUILDING ELEVATION

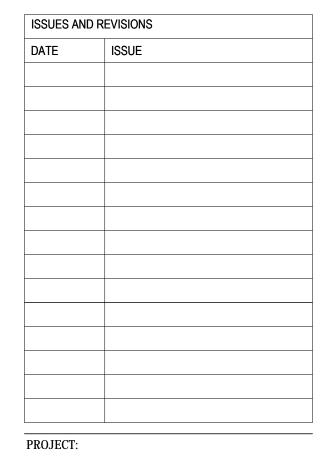


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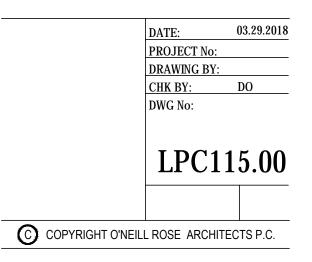
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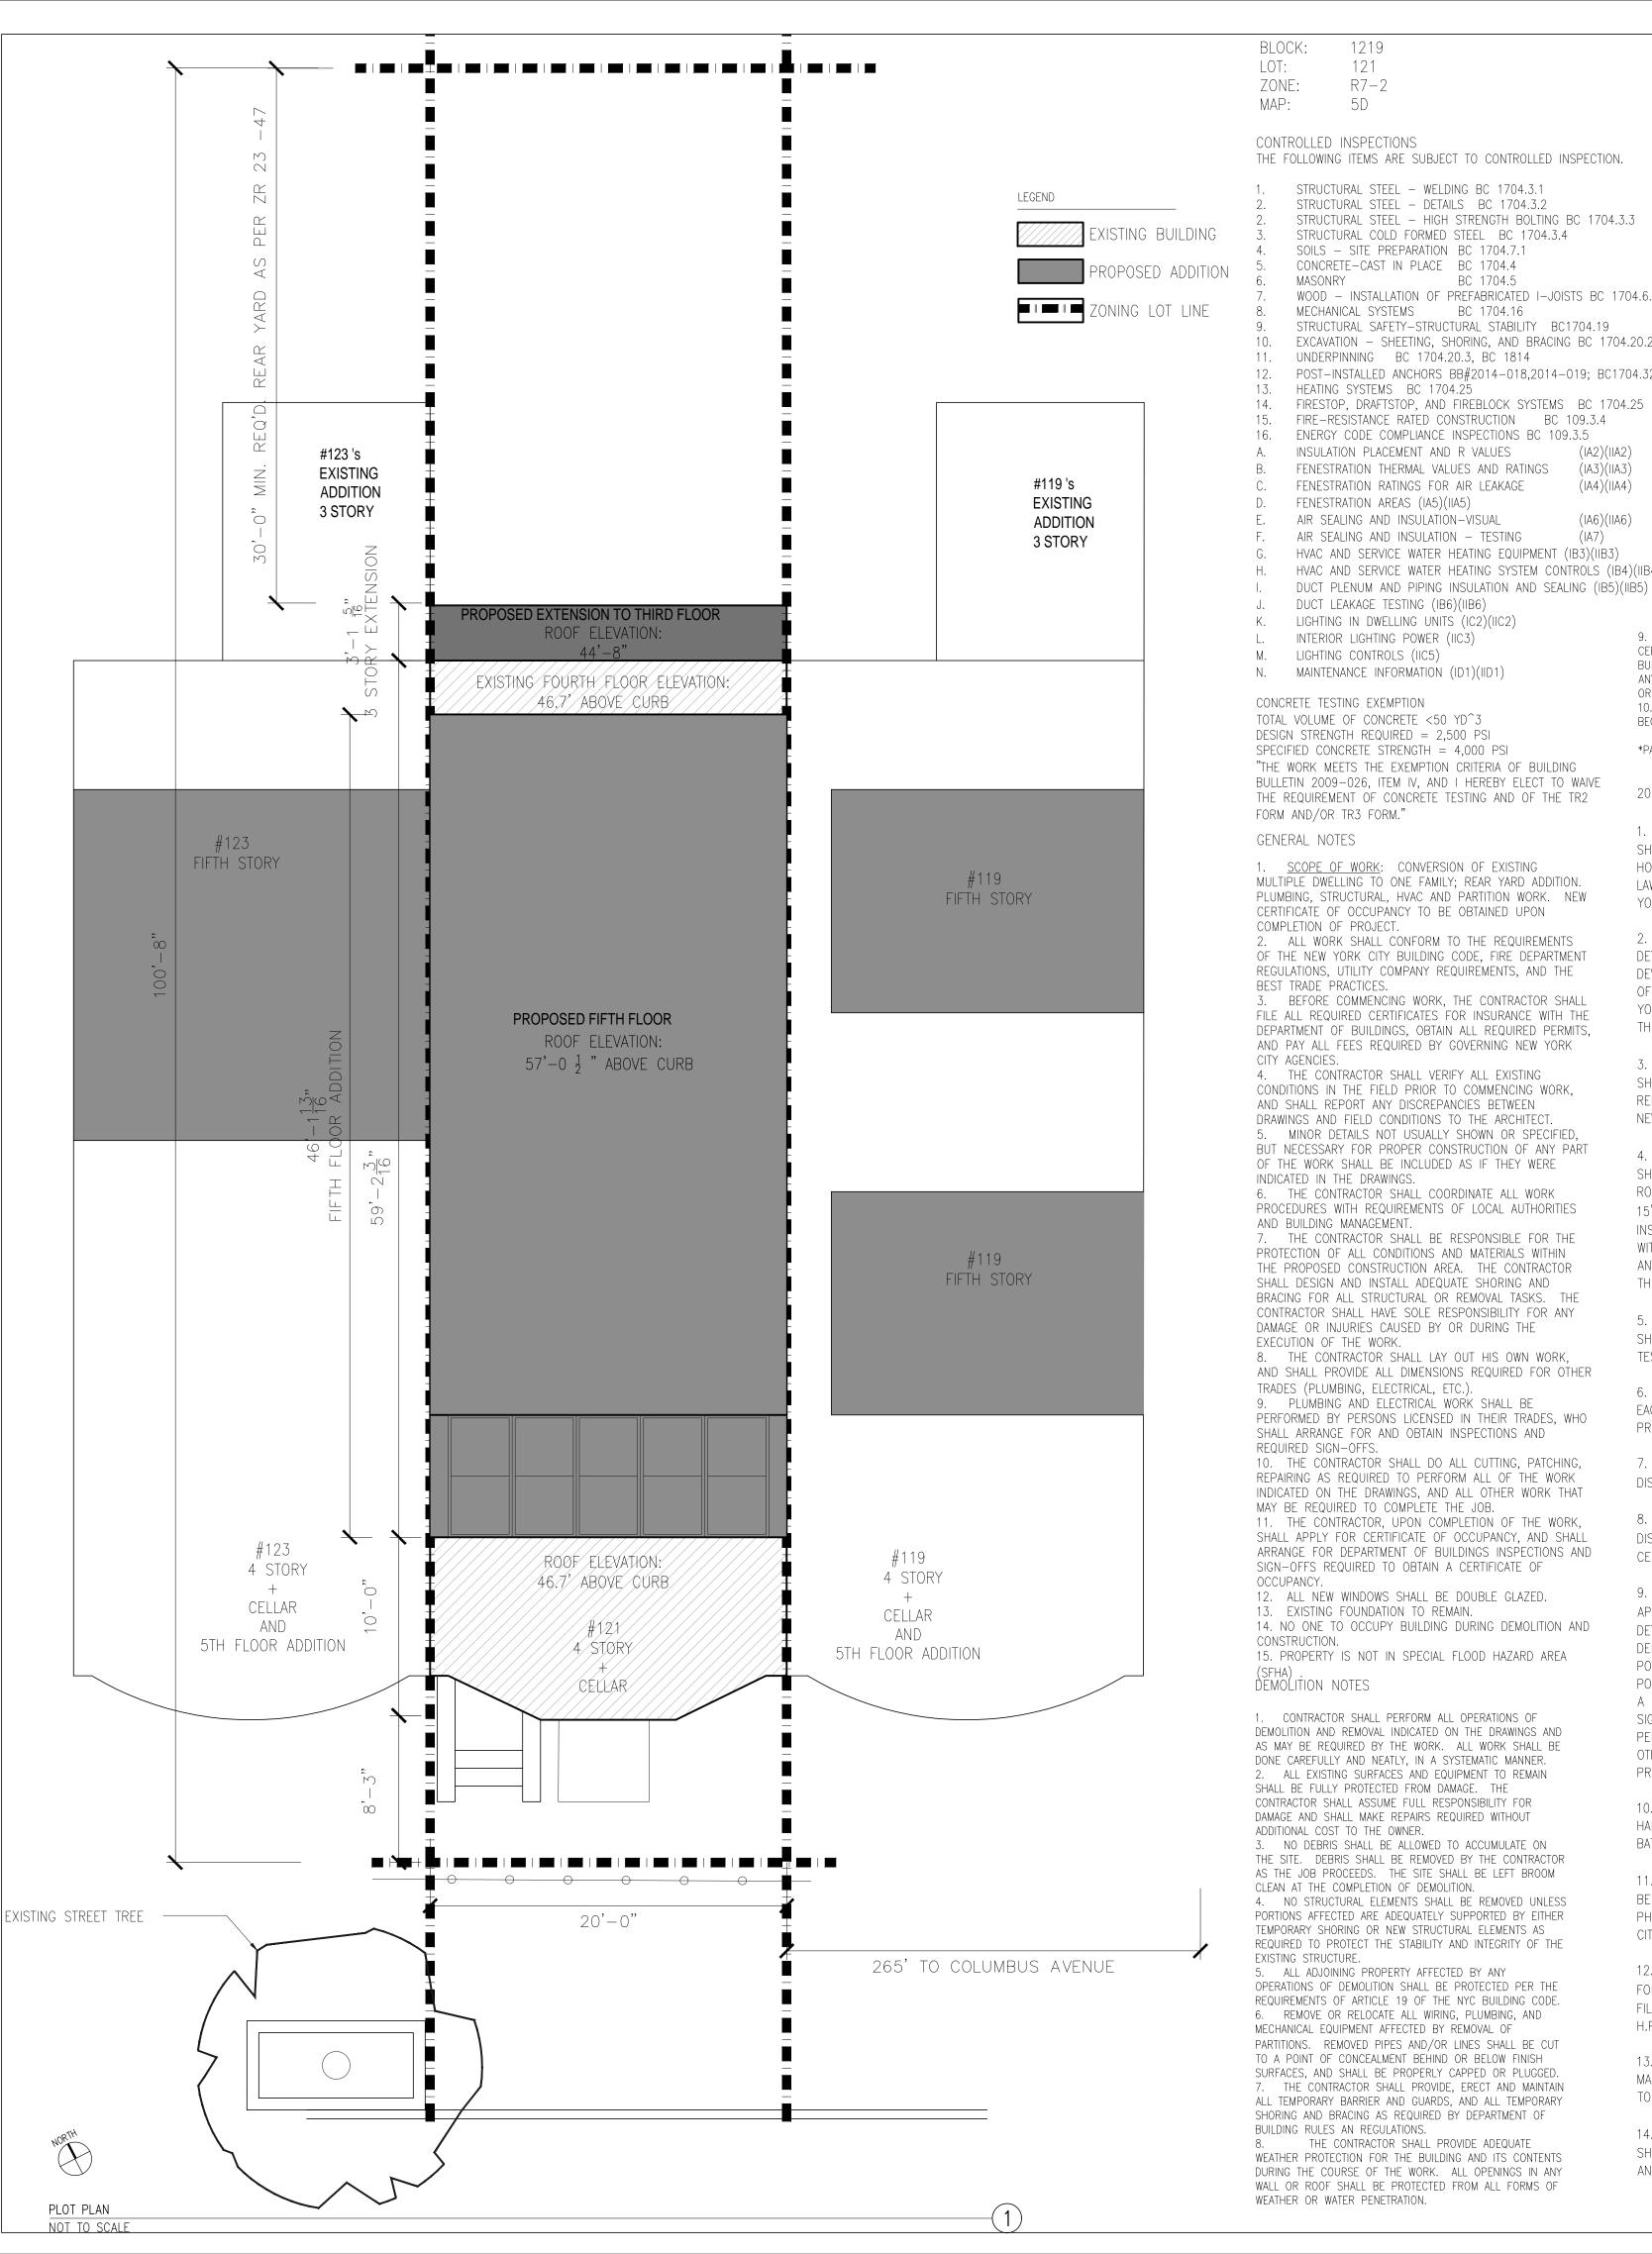
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121 WEST 88TH STREET NEW YORK, NY 10024

PROPOSED REAR ELEVATION





CONTROLLED INSPECTIONS THE FOLLOWING ITEMS ARE SUBJECT TO CONTROLLED INSPECTION. STRUCTURAL STEEL - WELDING BC 1704.3.1 STRUCTURAL STEEL - DETAILS BC 1704.3.2 STRUCTURAL STEEL - HIGH STRENGTH BOLTING BC 1704.3.3 STRUCTURAL COLD FORMED STEEL BC 1704.3.4 SOILS - SITE PREPARATION BC 1704.7.1 CONCRETE-CAST IN PLACE BC 1704.4 BC 1704.5 WOOD - INSTALLATION OF PREFABRICATED I-JOISTS BC 1704.6.3 MECHANICAL SYSTEMS BC 1704.16 STRUCTURAL SAFETY-STRUCTURAL STABILITY BC1704.19

BLOCK PLAN

9. THE CONTRACTOR SHALL FILE ALL NECESSARY

ORDER TO DO THE WORK HEREIN DESCRIBED

BEGIN AT HIGHEST LEVEL DOWN TO SUB CELLAR

\*PARTIAL DEMO WILL BE IDENTIFIED ON PM FORM

SHALL BE INSTALLED IN ORDINANCE WITH THE

YORK CITY ELECTRICAL CODE AND NFPA 72.

2. SMOKE DETECTORS AND CARBON MONOXIDE

DETECTORS MAY BE COMBINED PROVIDING THE

YORK ANY APPLICABLE RULES PROMULGATED

SHALL BE INSTALLED IN ACCORDANCE WITH

NEW YORK CITY BUILDING CODE.

3. EACH SMOKE/CARBON MONOXIDE DETECTORS

4. EACH SMOKE/CARBON MONOXIDE DETECTORS

ROOM AND IN THE IMMEDIATE VICINITY OR WITHIN

15'-0" OF THE ENTRANCE TO THE SLEEPING ROOM;

INSIDE EACH SLEEPING ROOM; AND ON EACH STORY

WITHIN A DWELLING UNIT, INCLUDING BELOW STORIES

AND PENTHOUSES PER 907.2.11.1 AND 908.7.1

5. EACH SMOKE/CARBON MONOXIDE DETECTORS

SHALL BE OF A TYPE THAT ALLOWS FOR READILY

6. DUPLEX UNITS SHALL HAVE A DEVICE LOCATED ON

EACH LEVEL IF ONLY ONE MEANS OF EGRESS IS

7. CEILING MOUNTED DEVICES SHALL BE A MINIMUM

8. WALL MOUNTED DEVICES SHALL BE A MINIMUM

DISTANCE OF 4" TO A MAXIMUM OF 12" FROM THE

9. EACH DWELLING SHALL BE EQUIPPED WITH AN

DEDICATED BRANCH CIRCUIT OR THE UNSWITCHED

PORTION OF A BRANCH CIRCUIT ALSO USED FOR

DETECTOR DEVICE RECEIVING PRIMARY POWER FROM A

POWER AND LIGHTING, AND SHALL BE EQUIPPED WITH

A BATTERY BACKUP. SMOKE ALARMS SHALL EMIT A

SIGNAL WHEN BATTERIES ARE LOW. WIRING SHALL BE

PERMANENT AND WITHOUT A DISCONNECTION SWITCH

10. EXISTING BUILDING THAT ARE NOT EQUIPPED WITH

11. SUCH SMOKE/CARBON MONOXIDE DETECTOR MUST

BE EITHER THE IONIZATION CHAMBER TYPE OR THE

PHOTOELECTRIC DETECTOR TYPE AS PER NEW YORK

12. A CERTIFICATE OF SATISFACTORY INSTALLATION

FILED WITH THE DIVISION OF CODE ENFORCEMENT

MAINTENANCE OF THE DEVICES SHALL BE PROVIDED

14. IN MULTIPLE DWELLINGS (R-2), SMOKE ALARMS

SHALL BE ABLE TO SUPPORT VISIBLE ALARM PER

FOR SMOKE/CARBON MONOXIDE DETECTORS MUST BE

CITY BUILDING CODE SEC. 907 AND 908.

H.P.D. 10 DAYS AFTER INSTALLATION.

TO THE DWELLING UNIT OWNER.

ANSI A117.1

13. WRITTEN INFORMATION OF TESTING AND

HARDWIRED CONNECTIONS SHALL BE SUPPLIED WITH

OTHER THAN AS REQUIRED FOR OVER-CURRENT

PROTECTION. 907.2.11.1 THROUGH 907.2.11.3.

BATTERY OPERATED DEVICES.

APPROVED TYPE SMOKE/CARBON MONOXIDE

REFERENCE STANDARD UL2034 AND UL2075 OF THE

THEREUNDER.

THROUGH 908.7.4.

TESTING OF SUCH DEVICE.

PROVIDED FROM EACH LEVEL.

CEILING.

DISTANCE OF 4" FROM ANY WALL.

HOUSING MAINTENANCE CODE, MULTIPLE DWELLING

LAW, THE NEW YORK CITY BUILDING CODE, THE NEW

DEVICES COMPLY WITH THE PROVISIONS OF TITLE 28

OF THE ADMINISTRATIVE CODE OF THE CITY OF NEW

2014 SMOKE/CARBON MONOXIDE NOTES:

CERTIFICATES OF INSURANCE WITH THE DEPARTMENT OF

ANY AND ALL BONDS REQUIRED BY ANY CITY AGENCY IN

NOT TO SCALE

BUILDINGS, PAY ALL FEES, OBTAIN ALL PERMITS AND PROVIDE

SEQUENCE OF DEMOLITION: INTERIOR DEMOLITION TO

1. SMOKE/CARBON MONOXIDE DETECTORS OR DEVICES

EXCAVATION - SHEETING, SHORING, AND BRACING BC 1704.20.2 UNDERPINNING BC 1704.20.3, BC 1814 POST-INSTALLED ANCHORS BB#2014-018,2014-019; BC1704.32 HEATING SYSTEMS BC 1704.25 FIRESTOP, DRAFTSTOP, AND FIREBLOCK SYSTEMS BC 1704.25 FIRE—RESISTANCE RATED CONSTRUCTION BC 109.3.4 ENERGY CODE COMPLIANCE INSPECTIONS BC 109.3.5

INSULATION PLACEMENT AND R VALUES (IA2)(IIA2) FENESTRATION THERMAL VALUES AND RATINGS (IA3)(IIA3) FENESTRATION RATINGS FOR AIR LEAKAGE (IA4)(IIA4) FENESTRATION AREAS (IA5)(IIA5) AIR SEALING AND INSULATION—VISUAL (IA6)(IIA6) AIR SEALING AND INSULATION — TESTING HVAC AND SERVICE WATER HEATING EQUIPMENT (IB3)(IIB3) HVAC AND SERVICE WATER HEATING SYSTEM CONTROLS (IB4)(IIB4)

DUCT LEAKAGE TESTING (IB6)(IIB6) LIGHTING IN DWELLING UNITS (IC2)(IIC2) INTERIOR LIGHTING POWER (IIC3) LIGHTING CONTROLS (IIC5) N. MAINTENANCE INFORMATION (ID1)(IID1)

CONCRETE TESTING EXEMPTION TOTAL VOLUME OF CONCRETE <50 YD^3 DESIGN STRENGTH REQUIRED = 2,500 PSI SPECIFIED CONCRETE STRENGTH = 4,000 PSI "THE WORK MEETS THE EXEMPTION CRITERIA OF BUILDING BULLETIN 2009-026, ITEM IV, AND I HEREBY ELECT TO WAIVE THE REQUIREMENT OF CONCRETE TESTING AND OF THE TR2 FORM AND/OR TR3 FORM."

1. <u>SCOPE OF WORK</u>: CONVERSION OF EXISTING MULTIPLE DWELLING TO ONE FAMILY; REAR YARD ADDITION. PLUMBING, STRUCTURAL, HVAC AND PARTITION WORK. NEW CERTIFICATE OF OCCUPANCY TO BE OBTAINED UPON COMPLETION OF PROJECT.

2. ALL WORK SHALL CONFORM TO THE REQUIREMENTS OF THE NEW YORK CITY BUILDING CODE, FIRE DEPARTMENT REGULATIONS, UTILITY COMPANY REQUIREMENTS, AND THE BEST TRADE PRACTICES. BEFORE COMMENCING WORK, THE CONTRACTOR SHALL

DEPARTMENT OF BUILDINGS, OBTAIN ALL REQUIRED PERMITS, AND PAY ALL FEES REQUIRED BY GOVERNING NEW YORK 4. THE CONTRACTOR SHALL VERIFY ALL EXISTING CONDITIONS IN THE FIELD PRIOR TO COMMENCING WORK, AND SHALL REPORT ANY DISCREPANCIES BETWEEN

DRAWINGS AND FIELD CONDITIONS TO THE ARCHITECT. MINOR DETAILS NOT USUALLY SHOWN OR SPECIFIED, BUT NECESSARY FOR PROPER CONSTRUCTION OF ANY PART OF THE WORK SHALL BE INCLUDED AS IF THEY WERE 6. THE CONTRACTOR SHALL COORDINATE ALL WORK

PROCEDURES WITH REQUIREMENTS OF LOCAL AUTHORITIES AND BUILDING MANAGEMENT. 7. THE CONTRACTOR SHALL BE RESPONSIBLE FOR THE PROTECTION OF ALL CONDITIONS AND MATERIALS WITHIN THE PROPOSED CONSTRUCTION AREA. THE CONTRACTOR SHALL DESIGN AND INSTALL ADEQUATE SHORING AND BRACING FOR ALL STRUCTURAL OR REMOVAL TASKS. THE CONTRACTOR SHALL HAVE SOLE RESPONSIBILITY FOR ANY DAMAGE OR INJURIES CAUSED BY OR DURING THE

8. THE CONTRACTOR SHALL LAY OUT HIS OWN WORK, AND SHALL PROVIDE ALL DIMENSIONS REQUIRED FOR OTHER TRADES (PLUMBING, ELECTRICAL, ETC.). 9. PLUMBING AND ELECTRICAL WORK SHALL BE PERFORMED BY PERSONS LICENSED IN THEIR TRADES, WHO SHALL ARRANGE FOR AND OBTAIN INSPECTIONS AND REQUIRED SIGN-OFFS. 10. THE CONTRACTOR SHALL DO ALL CUTTING, PATCHING, REPAIRING AS REQUIRED TO PERFORM ALL OF THE WORK INDICATED ON THE DRAWINGS, AND ALL OTHER WORK THAT MAY BE REQUIRED TO COMPLETE THE JOB.

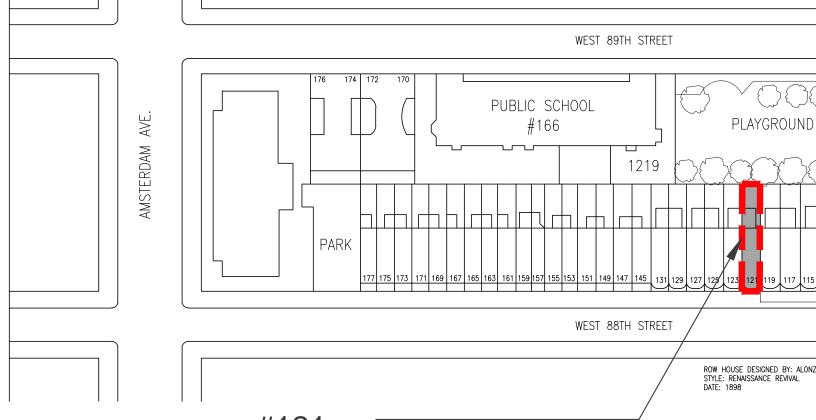
SIGN-OFFS REQUIRED TO OBTAIN A CERTIFICATE OF 12. ALL NEW WINDOWS SHALL BE DOUBLE GLAZED. 13. EXISTING FOUNDATION TO REMAIN. 14. NO ONE TO OCCUPY BUILDING DURING DEMOLITION AND 15. PROPERTY IS NOT IN SPECIAL FLOOD HAZARD AREA

1. CONTRACTOR SHALL PERFORM ALL OPERATIONS OF DEMOLITION AND REMOVAL INDICATED ON THE DRAWINGS AND AS MAY BE REQUIRED BY THE WORK. ALL WORK SHALL BE DONE CAREFULLY AND NEATLY, IN A SYSTEMATIC MANNER. 2. ALL EXISTING SURFACES AND EQUIPMENT TO REMAIN SHALL BE FULLY PROTECTED FROM DAMAGE. THE CONTRACTOR SHALL ASSUME FULL RESPONSIBILITY FOR DAMAGE AND SHALL MAKE REPAIRS REQUIRED WITHOUT

ADDITIONAL COST TO THE OWNER. 3. NO DEBRIS SHALL BE ALLOWED TO ACCUMULATE ON THE SITE. DEBRIS SHALL BE REMOVED BY THE CONTRACTOR AS THE JOB PROCEEDS. THE SITE SHALL BE LEFT BROOM CLEAN AT THE COMPLETION OF DEMOLITION. 4. NO STRUCTURAL ELEMENTS SHALL BE REMOVED UNLESS PORTIONS AFFECTED ARE ADEQUATELY SUPPORTED BY EITHER TEMPORARY SHORING OR NEW STRUCTURAL ELEMENTS AS REQUIRED TO PROTECT THE STABILITY AND INTEGRITY OF THE EXISTING STRUCTURE

5. ALL ADJOINING PROPERTY AFFECTED BY ANY OPERATIONS OF DEMOLITION SHALL BE PROTECTED PER THE REQUIREMENTS OF ARTICLE 19 OF THE NYC BUILDING CODE. 6. REMOVE OR RELOCATE ALL WIRING, PLUMBING, AND MECHANICAL EQUIPMENT AFFECTED BY REMOVAL OF PARTITIONS. REMOVED PIPES AND/OR LINES SHALL BE CUT TO A POINT OF CONCEALMENT BEHIND OR BELOW FINISH SURFACES, AND SHALL BE PROPERLY CAPPED OR PLUGGED. THE CONTRACTOR SHALL PROVIDE, ERECT AND MAINTAIN ALL TEMPORARY BARRIER AND GUARDS, AND ALL TEMPORARY SHORING AND BRACING AS REQUIRED BY DEPARTMENT OF

BUILDING RULES AN REGULATIONS. THE CONTRACTOR SHALL PROVIDE ADEQUATE WEATHER PROTECTION FOR THE BUILDING AND ITS CONTENTS DURING THE COURSE OF THE WORK. ALL OPENINGS IN ANY WALL OR ROOF SHALL BE PROTECTED FROM ALL FORMS OF WEATHER OR WATER PENETRATION.



# #121 BUILDING LOCATION

2014 PLUMBING AND DRAINAGE NOTES

1. ALL PLUMBING AND GAS PIPING WORK SHALL BE INSTALLED IN STRICT ACCORDANCE WITH THE REQUIREMENTS OF ARTICLE 16 AND REFERENCE STANDARD RS-16 OF THE NYC BUILDING CODE.

2. PLUMBING FIXTURES SHALL BE OF TYPE AND MANUFACTURE APPROVED FOR USE IN NEW YORK CITY, AND SHALL BEAR BS&A APPROVAL.

3. ALL GAS-FIRED EQUIPMENT TO BE A.G.A. OR M.E.A. APPROVED.

4. PLUMBING CONTRACTOR TO EXAMINE PROPOSED LAYOUT WITH REGARD TO EXISTING FIELD CONDITIONS, AND SHALL NOTIFY ARCHITECT OF ANY DISCREPANCIES BETWEEN ASSUMED FIELD CONDITIONS AND THOSE ENCOUNTERED DURING CONSTRUCTION. PLUMBING CONTRACTOR SHALL INFORM ARCHITECT OF ANY REVISIONS TO PLAN WHICH SHALL BE NECESSARY, BASED ON CONDITIONS UNCOVERED IN THE FIELD, IN ORDER TO INSTALL ALL FIXTURES, EQUIPMENT AND PIPING IN STRICT ACCORDANCE WITH THE REQUIREMENTS OF THE NYC BUILDING CODE.

5. PLUMBING CONTRACTOR SHALL ARRANGE AND OBTAIN INSPECTIONS AND REQUIRED SIGN-OFFS.

### HOUSING MAINTENANCE CODE NOTES

1. OWNER TO MAINTAIN PAINT OR OTHER WALL COVERING IN ALL TENANT-OCCUPIED SPACES, AS PER D26-12.01.

2. OWNER TO MAINTAIN PAINTING OF EXTERIOR WINDOW FRAMES AND SASHES BY REPAINTING WITH AT LEAST ONE COAT OF PAINT EVERY FIVE YEARS, AS PER D26-21.03A.

3. OWNER SHALL KEEP PREMISES FREE FROM CONDITION CONDUCIVE TO RODENTS, INSECTS AND OTHER PESTS, AND FROM ANY CONDITION CONDUCIVE TO RODENT AND INSECT AND OTHER PEST LIFE, AS PER

D26-13.03.

4. OWNER TO PROVIDE FOR THE REGULAR COLLECTION OF WASTE MATTER AND SHALL NOT PERMIT OR SOURCES OF IGNITION. ANY TYPE OF WASTE MATTER TO ACCUMULATE SO AS TO CREATE A CONDITION WHICH IS UNSANITARY OR A FIRE HAZARD, AS PER D26-14.07.

5. OWNER SHALL MAINTAIN A SUPPLY OF PURE WATER SUFFICIENT IN QUANTITY AND IN PRESSURE TO DEEP ALL PLUMBING FIXTURES ADEQUATELY SUPPLIED FOR THEIR SANITARY MAINTENANCE, AS PER D26-15.01. ALSO, OWNER SHALL PROVIDE PROPER APPLIANCES TO RECEIVE AND DISTRIBUTE AN ADEQUATE SUPPLY OF WATER AT ALL HOURS, AS PER D26-15.03.

6. OWNER SHALL MAINTAIN AND KEEP IN GOOD REPAIR THE PLUMBING AND DRAINAGE SYSTEM, AS PER D26-16.01. ALSO, THE OWNER SHALL MAINTAIN THE GRADE OF ROOFS AND ALL OPEN SPACES ON THE LOT, AND SHALL MAINTAIN UNOBSTRUCTED DRAINAGE FROM THESE AREAS THROUGH A DRAIN CONNECTED TO A STREET STORM-WATER MAIN, AS PER D26-16.03.

7. OWNER SHALL PROVIDE HEAT FROM A CENTRAL HEATING SYSTEM, SHALL MAINTAIN REQUIRED TEMPERATURES DURING THE PERIOD FORM OCTOBER 1 THROUGH MAY 31, AS PER D26-17.01 AND 17.03. IF APARTMENT DURING CONSTRUCTION. A BREAKDOWN OF THE HEATING SYSTEM IS TO OCCUR, THE OWNER SHALL PROVIDE INSPECTIONS OF THE HEATING SYSTEM A PER THE REQUIREMENTS OF

8. HOT WATER SHALL BE SUPPLIED BETWEEN THE HOURS OF SIX A.M. AND MIDNIGHT AT A CONSTANT TEMPERATURE OF 120 DEGREES FAHRENHEIT, AS PER THE REQUIREMENTS OF D26-17.07.

BY ELECTRICITY, AND SHALL PROVIDE AND MAINTAIN AND FOR ALL ROOMS, AS PER D26-19.01.

10. PEEPHOLES OR OTHER MEANS OF VIEWING THE ENTRANCE AREA TO BE PROVIDED AS PER THE REQUIREMENTS OF D26-20.01.

11. LIGHTING AND VENTILATION SHALL MEET THE REQUIREMENTS OF D26-30.11 WITH REGARD TO THE NUMBER AND TYPE OF WINDOWS REQUIRED AND THE SIZE OF REQUIRED WINDOWS.

28-104.8.4 TENANT PROTECTION PLAN. 2014

CONSTRUCTION DOCUMENTS FOR ALTERATIONS OF BUILDINGS IN WHICH ANY DWELLING UNIT WILL BE OCCUPIED DURING CONSTRUCTION SHALL INCLUDE A TENANT PROTECTION PLAN. SUCH PLAN SHALL CONTAIN A

STATEMENT THAT THE BUILDING CONTAINS DWELLING UNITS THAT WILL BE OCCUPIED DURING CONSTRUCTION AND SHALL INDICATE IN SUFFICIENT DETAIL THE SPECIFIC UNITS THAT ARE OR MAY BE OCCUPIED

CONSTRUCTION, THE MEANS AND METHODS TO BE EMPLOYED TO SAFEGUARD THE SAFETY AND HEALTH OF THE OCCUPANTS, INCLUDING, WHERE APPLICABLE, DETAILS SUCH AS TEMPORARY FIRE-RATED ASSEMBLIES,

OPENING PROTECTIVES, OR DUST CONTAINMENT PROCEDURES. THE ELEMENTS OF THE TENANT PROTECTION

PLAN MAY VARY DEPENDING ON THE NATURE AND SCOPE OF THE WORK BUT AT A MINIMUM SHALL MAKE DETAILED AND SPECIFIC PROVISIONS FOR: 1. EGRESS. AT ALL TIMES IN THE COURSE OF CONSTRUCTION PROVISION SHALL BE MADE FOR ADEQUATE EGRESS

AS REQUIRED BY THIS CODE AND THE TENANT PROTECTION PLAN SHALL IDENTIFY THE EGRESS THAT WILL BE PROVIDED. REQUIRED EGRESS SHALL NOT BE OBSTRUCTED AT ANY TIME EXCEPT WHERE APPROVED

THE COMMISSIONER.

1.1. REFER TO DRAWING T-## FOR SITE/KEY PLAN IDENTIFYING EGRESS PATH THAT SHALL BE MAINTAINED AT ALL TIMES DURING CONSTRUCTION. 1.2. NO CONSTRUCTION MATERIALS ARE TO BE PLACED OR STORED IN ANY REQUIRED PATH OF EGRESS. ALL MATERIALS ARE TO BE STORED IN AN ORDERLY

FASHION. FIRE SAFETY. ALL NECESSARY LAWS AND CONTROLS, INCLUDING THOSE WITH RESPECT TO

DWELLINGS, AS WELL AS ADDITIONAL SAFETY MEASURES NECESSITATED BY THE CONSTRUCTION SHALL BE

STRICTLY OBSERVED. RODENTS, INSECTS AND OTHER PESTS, AND FROM ANY 2.1. ALL FLAMMABLE CONSTRUCTION MATERIALS WILL BE KEPT TIGHTLY SEALED IN THEIR RESPECTIVE MANUFACTURERS' CONTAINERS. 2.2. ALL FLAMMABLE MATERIALS TO BE USED AND

STORED IN AN ADEQUATELY VENTILATED SPACE. SUCH MATERIALS ARE TO BE KEPT AWAY FROM HEAT HEALTH REQUIREMENTS. SPECIFICATION OF MEANS AND METHODS TO BE USED FOR CONTROL OF

DISPOSAL OF CONSTRUCTION DEBRIS, PEST CONTROL AND MAINTENANCE OF SANITARY FACILITIES, AND LIMITATION OF NOISE TO ACCEPTABLE LEVELS SHALL BE INCLUDED. 3.1. THERE SHALL BE INCLUDED A STATEMENT OF

COMPLIANCE WITH APPLICABLE PROVISIONS OF LAW RELATING TO LEAD AND ASBESTOS, AND SUCH STATEMENT SHALL DESCRIBE WITH PARTICULARITY WHAT MEANS AND METHODS ARE BEING UNDERTAKEN TO MEET SUCH COMPLIANCE.

3.1.1. PROVIDE STATEMENT FOR LEAD. 3.1.2. PROVIDE STATEMENT FOR ASBESTOS. 3.2. THE ENTRANCE DOOR TO THE AREA OF WORK WILL BE ENCAPSULATED IN PLASTIC TO PREVENT DUST

4. COMPLIANCE WITH HOUSING STANDARDS. THE REQUIREMENTS OF THE NEW YORK CITY HOUSING MAINTENANCE CODE, AND, WHERE APPLICABLE, THE NEW YORK STATE MULTIPLE DWELLING LAW SHALL BE STRICTLY OBSERVED

AND AIRBORNE PARTICLES FROM MOVING INTO THE

PUBLIC CORRIDOR AND STAIRWELLS FROM THE

STRUCTURAL SAFETY. NO STRUCTURAL WORK SHALL BE DONE THAT MAY ENDANGER THE OCCUPANTS.

9. OWNER SHALL EQUIP ALL DWELLINGS FOR LIGHTING 5.1. THE SIA ASSIGNED FOR STRUCTURAL WORK WILL MAINTAIN A LOG TO VERIFY COMPLIANCE WITH THE LIGHT FIXTURES FOR ALL PUBLIC PARTS IN A DWELLING TENANT SAFETY PLAN IDENTIFIED ON THE STRUCTURAL DRAWINGS.

5.2. THE SIA WILL BE ONSITE FOR EACH NEW PHASE OF STRUCTURAL WORK TO VERIFY THAT THE SEQUENCE AND MANNER OF WORK IS UNDERTAKEN AS OUTLINED IN THE STRUCTURAL DRAWINGS. 5.3. ALL EQUIPMENT AND TOOLS USED DURING THE CONSTRUCTION OF THIS PROJECT WILL COMPLY WITH THESUBMITTED DS1 FORM.

6. NOISE RESTRICTIONS. WHERE HOURS OF THE DAY OR THE DAYS OF THE WEEK IN WHICH CONSTRUCTION WORK

265'-0" TO COLUMBUS AVE

MAY BE UNDERTAKEN ARE LIMITED PURSUANT TO THE NEW YORK CITY NOISE CONTROL CODE, WORK PERMITTED MONDAY TO FRIDAY 7AM TO 6PM.

6.1. HOURS OF CONSTRUCTION ARE TO BE #:## TO #:## MONDAY THRU FRIDAY. 6.2. AN AFTER HOURS VARIANCE MUST BE OBTAINED FROM THE NYC DEPARTMENT OF BUILDINGS PRIOR TO COMMENCING ANY CONSTRUCTION BEYOND THE PERMITTED TIMES IDENTIFIED ABOVE.

7. MAINTAINING ESSENTIAL SERVICES. WHERE HEAT, HOT WATER, COLD WATER, GAS, ELECTRICITY, OR OTHER UTILITY SERVICES ARE PROVIDED IN SUCH BUILDING OR IN ANY DWELLING UNIT LOCATED THEREIN, THE

TENANT PROTECTION PLAN SHALL SPECIFY THE MEANS AND METHODS TO BE USED FOR MAINTAINING SUCH SERVICES DURING SUCH WORK IN ACCORDANCE WITH THE REQUIREMENTS OF THE NEW YORK CITY HOUSING

MAINTENANCE CODE. IF A DISRUPTION OF ANY SUCH SERVICE IS ANTICIPATED DURING THE WORK. SUCH PLAN SHALL SPECIFY THE ANTICIPATED

DURATION OF SUCH DISRUPTION AND THE MEANS METHODS TO BE EMPLOYED TO MINIMIZE SUCH

DISRUPTION, INCLUDING THE PROVISION OF SUFFICIENT ALTERNATIVES FOR SUCH SERVICE DURING SUCH DISRUPTION.

§ 28-104.8.4.1 PUBLIC AVAILABILITY OF TENANT PROTECTION PLAN. UPON ISSUANCE OF A PERMIT FOR WORK CONTAINING A TENANT PROTECTION PLAN. THE DEPARTMENT SHALL MAKE THE TENANT PROTECTION

PUBLICLY AVAILABLE ON ITS WEBSITE. 28-104.8.4.2 PROVISION OF COPY OF TENANT PROTECTION PLAN TO OCCUPANTS UPON REQUEST. THE OWNER OF A BUILDING UNDERGOING WORK FOR WHICH A TENANT PROTECTION PLAN IS REQUIRED

SECTION 28-104.8.4 SHALL, UPON REQUEST FROM AN OCCUPANT OF A DWELLING UNIT WITHIN SUCH BUILDING, PROVIDE SUCH OCCUPANT WITH A PAPER COPY OF THE TENANT PROTECTION PLAN

APPROVED BY THE DEPARTMENT. 28-104.8.4.3 NOTICE TO OCCUPANTS. UPON ISSUANCE OF A PERMIT FOR WORK CONTAINING A

PROTECTION PLAN, THE OWNER SHALL: DISTRIBUTE A NOTICE REGARDING SUCH PLAN TO EACH OCCUPIED DWELLING UNIT OR ii) POST A NOTICE REGARDING SUCH PLAN IN A CONSPICUOUS MANNER IN THE BUILDING LOBBY,

WELL AS ON EACH FLOOR WITHIN TEN FEET OF THE ELEVATOR, OR IN A BUILDING WHERE THERE

ELEVATOR, WITHIN TEN FEET OF OR IN THE MAIN STAIRWELL ON SUCH FLOOR. THE NOTICE SHALL BE IN A FORM CREATED OR APPROVED BY THE DEPARTMENT AND SHALL INCLUDE:

THE OCCUPANTS OF THE BUILDING MAY OBTAIN A PAPER COPY OF SUCH PLAN FROM THE OWNER AND MAY ACCESS SUCH PLAN ON THE DEPARTMENT

WEBSITE 2. THE NAME AND CONTACT INFORMATION FOR THE SITE SAFETY MANAGER, SITE SAFETY

COORDINATOR OR SUPERINTENDENT OF CONSTRUCTION REQUIRED BY SECTION 3301.3 OF THE NEW YORK CITY BUILDING

AS APPLICABLE, OR, IF THERE IS NO SITE SAFETY MANAGER, SITE SAFETY COORDINATOR OR SUPERINTENDENT OF CONSTRUCTION, THE NAME AND CONTACT INFORMATION OF THE OWNER OF THE BUILDING OR

OWNER'S DESIGNEE . THE OCCUPANTS OF THE BUILDING MAY CALL 311 TO MAKE A COMPLAINT ABOUT THE WORK

ISSUES AND REVISIONS DOB REVIEW 10.17.18

O'NEILL ROSE llc

ARCHITECTS

98 4TH STREET SUITE 419

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PROJECT:

LI RESIDENCE 121 WEST 88TH ST. NEW YORK, NY 10024

PLOT PLAN & GENERAL NOTES

10/05/18

LPC116.00



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ADDRESS: 121 WEST 88TH STREET ZONING DISTRICT: BLOCK: 1219 LOT: ZONING MAP:

CELLAR & FOUR STORIES (46.7') EXISTING HEIGHT: PROPOSED HEIGHT: CELLAR & FIVE STORIES  $(57' - \frac{1}{2}")$ 

EXISTING CONSTRUCTION CLASSIFICATION: CLASS 3 NON-FIREPROOF EXISTING USE: RESIDENTIAL - FIVE FAMILIES (C2) PROPOSED USE: RESIDENTIAL - SINGLE FAMILY (R3)

TOTAL LOT AREA:

FLOOR AREA RATIO (ZR - 23 - 153)

PROPOSED FLOOR AREA = 5544.7286 SQ.FT < 6924.72 SQ.FT - O.K.

EXISTING FAR: 5095.489 SQ.FT / 2,013.33 SQ.FT = 2.53

PROPOSED FAR: 5544.7286 SQ.FT / 2,013.33 SQ.FT = 2.754 < 3.44 - O.K.

1311.8806 SQ FT / 2013 SQFT X 100% = 65.17%

PROPOSED LOT COVERAGE: 57'-1" X 20'-0" + (2'-5" X 5'-2")/2 + (2'-5" X 5'-2")/2 + 2'-5" X 7'-8"+3'-1"X20'-0"

=1234.3506 SQ FT PROPOSED

MINIMUM BASE HEIGHT: 40' -0"

MAXIMUM BUILDING HEIGHT: 75'-0"

PROPOSED BUILDING HEIGHT:  $57' - \frac{1}{2}" < 75' - 0" - O.K.$ 

NO PORTION OF THE BUILDING EXCEEDS THE MAXIMUM BASE HEIGHT. NO SETBACK REQUIRED.

### STREET TREE PLANTING IN RESIDENCE DISTRICTS (ZR 23-03)

UNDER ZR-2303 (a), ENLARGEMENT OF SINGLE RESIDENCE SHALL NOT BE REQUIRED FOR STREET TREE.

### **DWELLING UNITS (ZR 23-22)**

MAXIMUM # OF DWELLING UNITS PERMITTED: 6925.8552SQ FT / 680 = 10.18 # OF DWELLING UNIT PROPOSED: 1 <10.18 -O.K.

# NO SIDE YARD REQUIRED

EXISTING:  $18' - 7\frac{5}{8}"$ 

### LEVEL OF YARDS (ZR 23-42)

THEIR PROLONGATIONS SHALL BE PLANTED AT GROUND LEVEL, OR IN RAISED PLANTING BEDS THAT ARE PERMANENTLY AFFIXED TO THE GROUND. NO PLANTING AT THE ENTRANCE AND EXIT FROM THE BUILDING. -O.K.

NOT SCALE

2,013.33 SQ.FT (20' 0"x 100.8')

MAXIMUM ALLOWABLE FLOOR AREA: LOT AREA 2,013.33 SF X 3.44 FAR = 6925.8552 SF

MAXIMUM RESIDENTIAL FAR: 3.44

### LOT COVERAGE (ZR - 23-153)

EXISTING LOT COVERAGE: 57'-1" X 20'-0" + (2'-5" X 5'-2")/2 + (2'-5" X 5'-2")/2 + 2'-5" X 7'-8" + 14.5' X 9.6' = 1311.8806 SQ FT

1234.3506 SQ FT / 2013 SQ FT X 100%= 61.31% < 65% (MAXIMUM) - O.K.

### MAXIMUM HEIGHT OF BUILDING AND SETBACK REGULATIONS (ZR 23-662)

## MAXIMUM BASE HEIGHT: 65'-0"

EXISTING BASE HEIGHT: 46.7'

PROPOSED BASE HEIGHT: 40'-0" < 46.7' < 65'-0" - O.K.

### SETBACK REGULATIONS (ZR 23-662)

### MINIMUM LOT WIDTH (ZR 23-32)

MINIMUM LOT WIDTH 18'-0" < EXISTING LOT WIDTH (NO CHANGE) 20'-0" -O.K.

### SIDE YARD (ZR 23-462)

### MINIMUM REQUIRED REAR YARD (ZR 23-47)

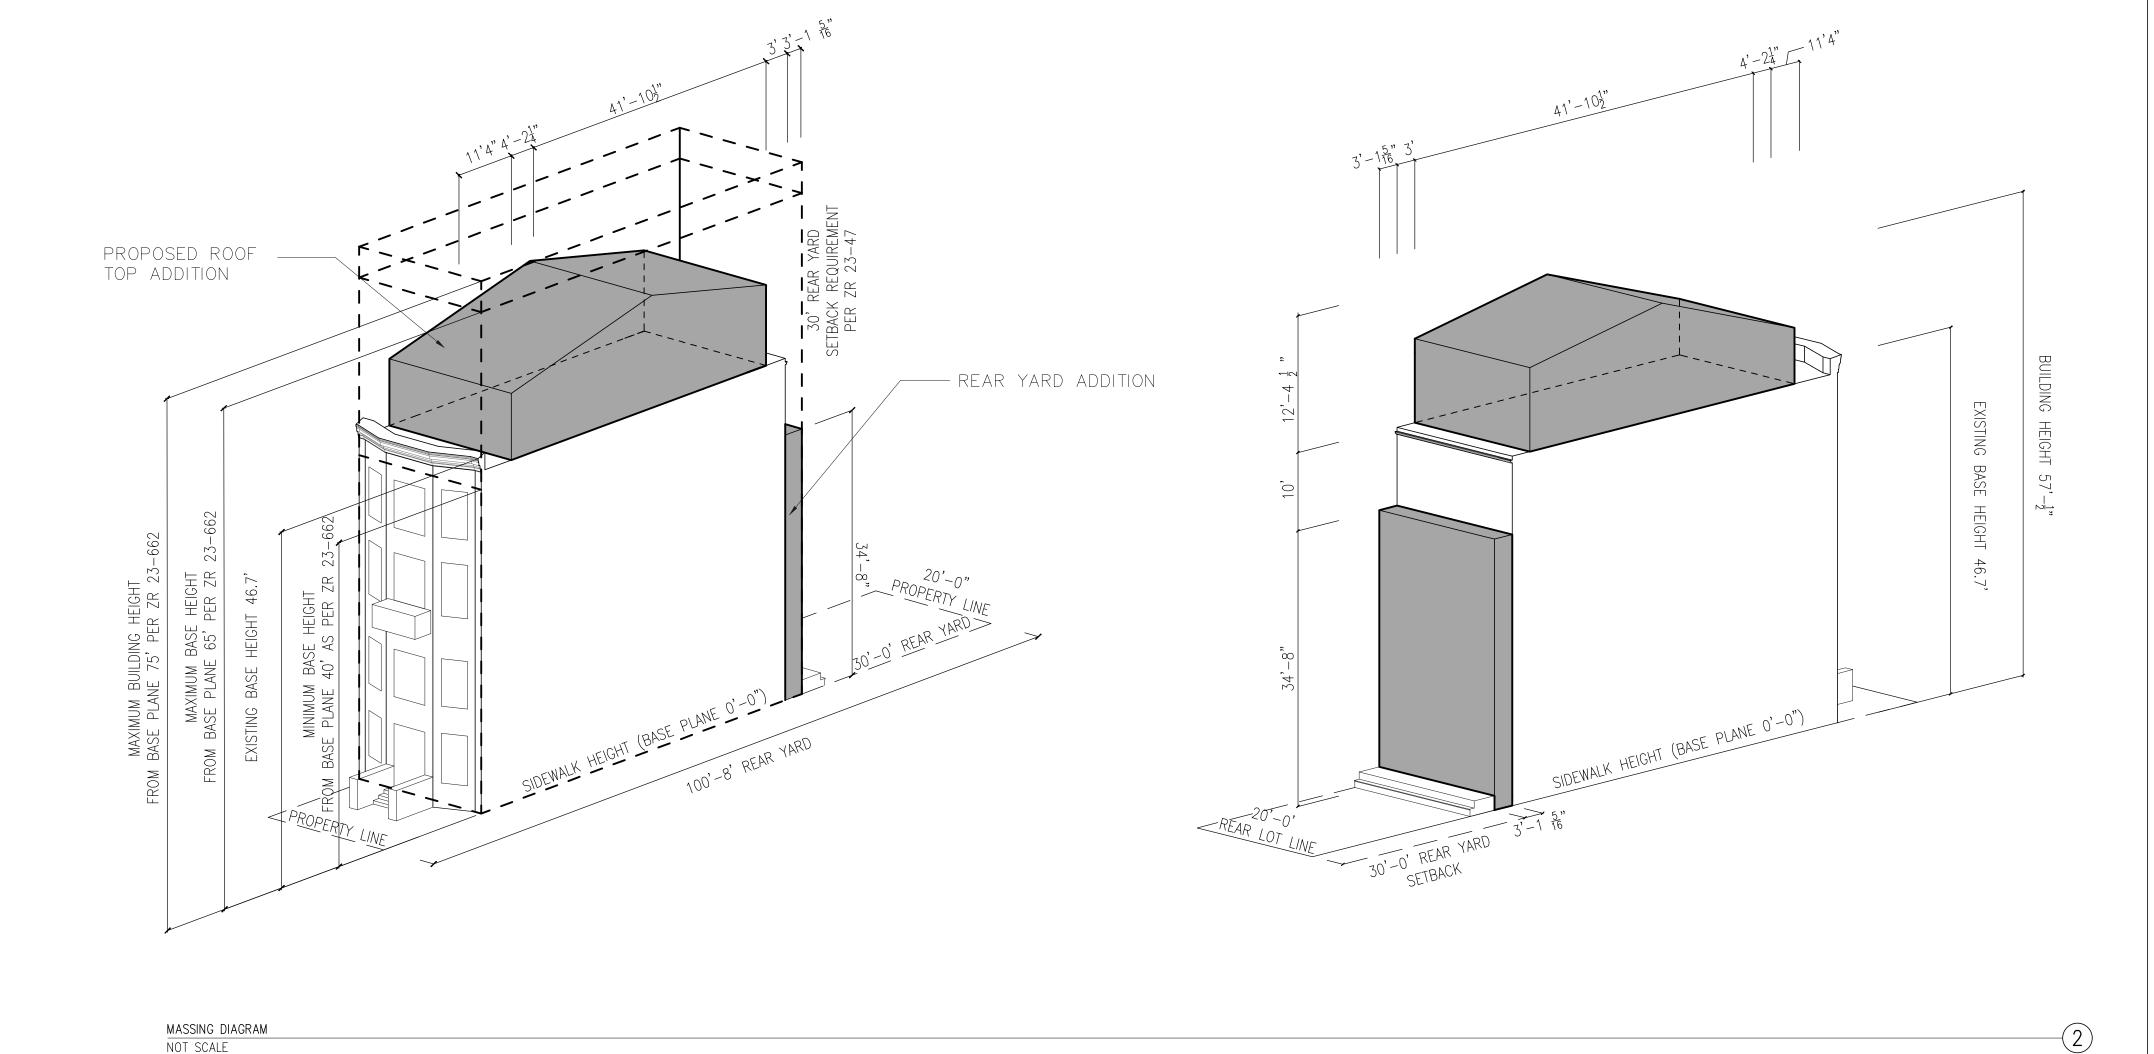
PROPOSED: 30' - 0" - O.K. REQUIRED: 30' - 0 "

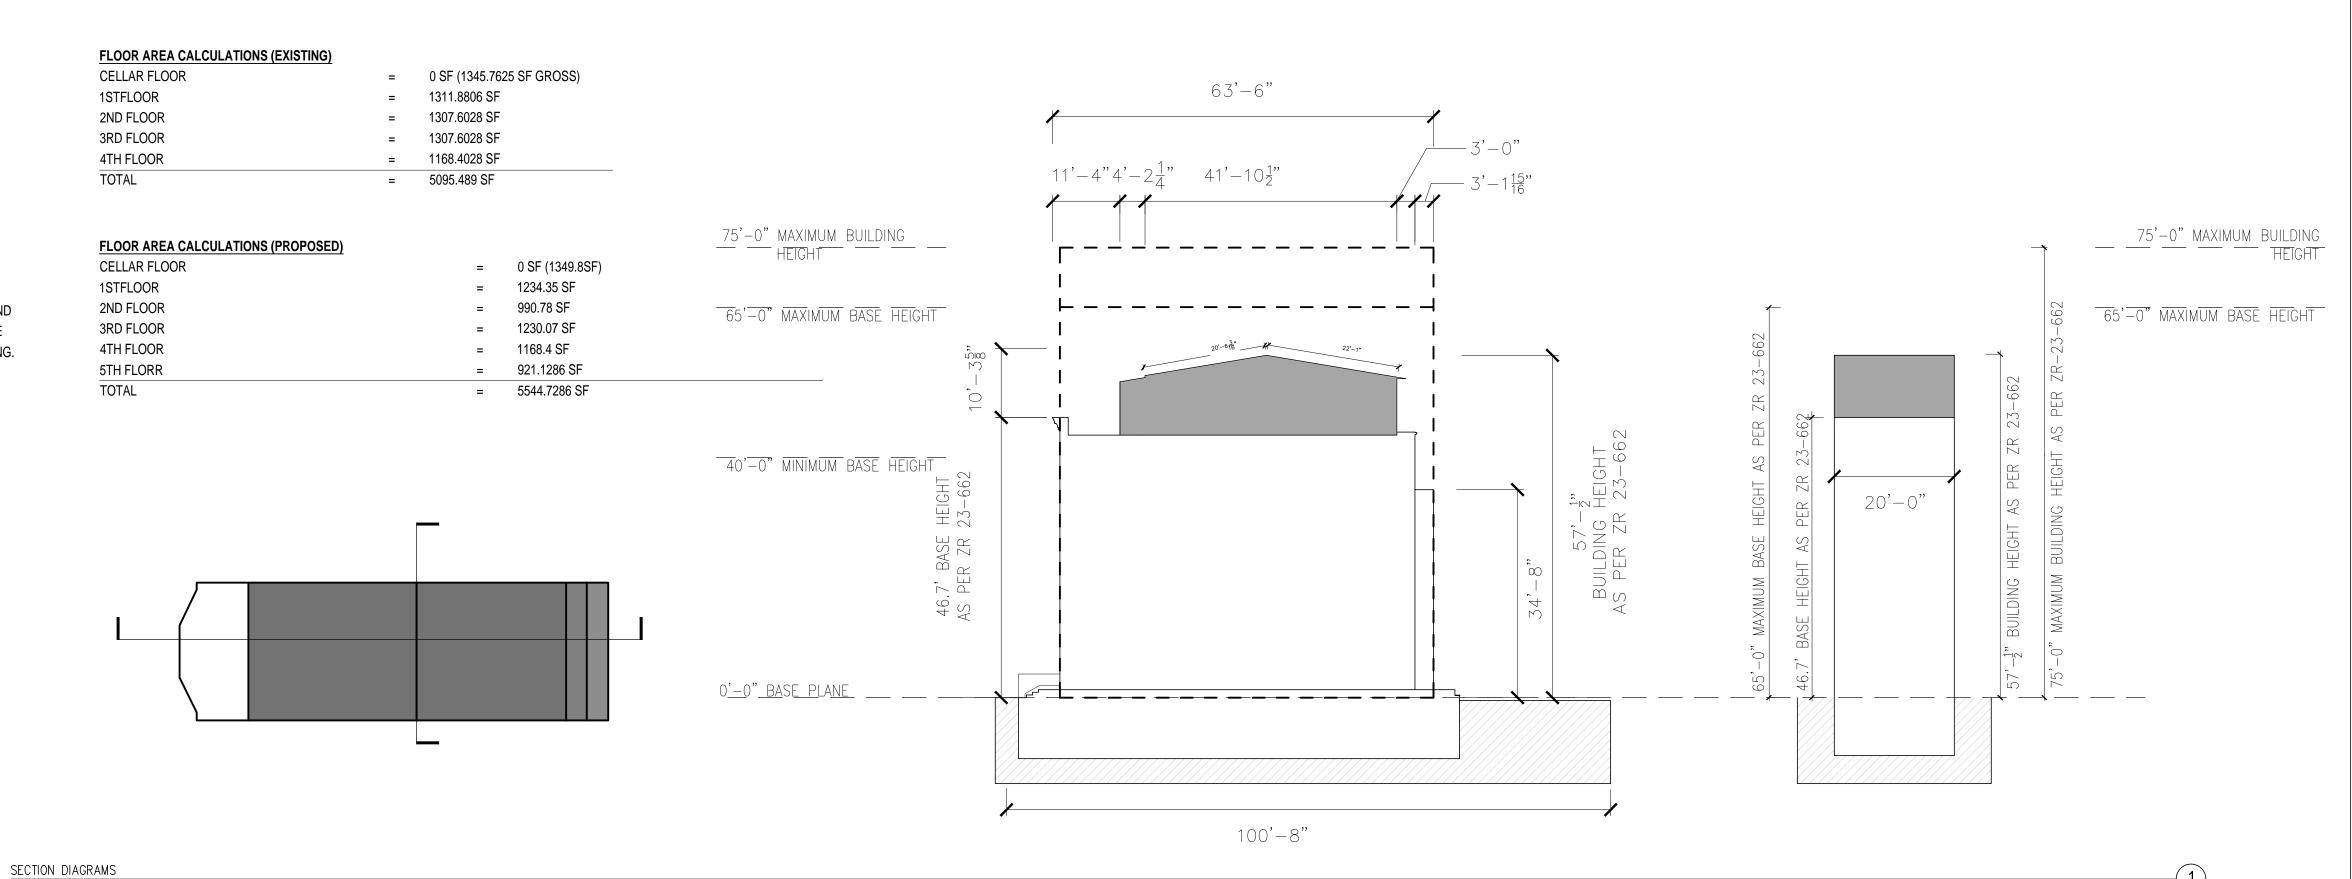
ALL YARDS MAY NOT BE HIGHER THAN CURB LEVEL, UNLESS NATURAL GRADE IS NOT DISTURBED

### **QHP: PLANTING AREAS (ZR 28-23)**

THE AREA OF THE ZONING LOT BETWEEN THE STREET LINE AND ALL STREET WALLS OF THE BUILDING AND

EXISTING MULTIPLE DWELLING LAW: HACA PROPOSED MULTIPLE DWELLING LAW: SINGLE FAMILY DWELLING





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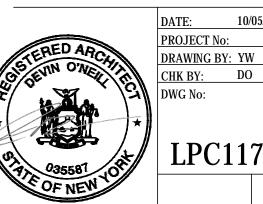
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**ZONING ANALYSIS & NOTES** 

10/05/18

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48'-2<u>5</u>" 30'-0" MIN. REQ'D. REAR YARD AS PER ZR 23 -47 3'-0"2'-1" 12'-0" PROPERTY LINE - AREA TO BE REMOVED: 138.69 SQ. FT. TO CONFORM TO 30'-0" EXISTING BUILDING: MIN REQ'D REAR YARD Second floor - 1168.4028 SQ FT AS PER ZR 23-47 ---DOUBLE HEIGHT SPACE OPEN TO BELOW PROPERTY LINE PROPOSED SECOND FLOOR PLAN: (AREA OF EXISTING BUILDING @ THIRD FLOOR = 48'-2 5/16" X 20'-0" + (2'-1"X5'-2")/2 + (2'-1"X5'-2")/2 + 2'-1"X 7'-8" = 990.78 SQ. FT.) PROPOSED SECOND FLOOR AREA AND LOT COVERAGE = 990.78 SQ. FT. PLAN AREA DIAGRAM - SECOND FLOOR 1/8" = 1'-0"57'-1" <sup>1</sup>30'-0" MIN. REQ'D. REAR YARD AS PER ZR 23 -47 — AREA TO BE REMOVED: 138.69 SQ. FT. TO CONFORM TO 30 - 0" EXISTING BUILDING: MIN REQ'D REAR YARD First floor - 1172.6806 SQ FT AS PER ZR 23-47 PROPERTY LINE PROPOSED FIRST FLOOR PLAN: (AREA OF EXISTING BUILDING @ FIRST FLOOR = 57'-1" X 20'-0" + (2'-5"X5'-2")/2 + (2'-5"X5'-2")/2 + 2'-5"X 7'-8" = 1172.6806 SQ. FT.) + (AREA OF PROPOSED EXTENSION = 3'-1" X 20'-0" = 61.67 SQ. FT.) PROPOSED FIRST FLOOR AREA AND LOT COVERAGE = 1234.3506 SQ. FT. PLAN AREA DIAGRAM - FIRST FLOOR 1/8" = 1'-0"100'-8"  $\frac{7'-1\frac{15}{16}"}{4}$ 57'-1" PROPERTY LINE -AREA TO BE REMOVED: 138.69 SQ. FT. TO CONFORM TO 30 - 0" EXISTING BUILDING: MIN REQ'D REAR YARD Cellar floor - 1206.5625 SQ FT AS PER ZR 23-47 PROPERTY LINE PROPOSED CELLAR FLOOR PLAN: (AREA OF EXISTING BUILDING @ CELLAR FLOOR = 57'-1" X 20'-0" + (2'-1" X 5'-4")/2 + (2'-1" X 5'-2")/2 + 7'-6" X 2'-1 $+ 6'-8" \times 5'-9" = 1206.5625 \text{ SQ. FT.}$ + (AREA OF PROPOSED EXTENSION =  $7'-1\frac{15}{16}$ " X 20'-0" = 143.2547 SQ. FT.) PROPOSED CELLAR FLOOR AREA AND LOT COVERAGE = 1349.8 SQ. FT. PLAN AREA DIAGRAM — CELLAR FLOOR 1/8" = 1'-0"

 $6'-1\frac{5}{16}$ " 30'-0" MIN. REQ'D. REAR YARD AS PER ZR 23 -47 46'-0<u>11</u>" 11'-4" PROPERTY LINE PROPOSED ADDITION: 921.1286 SQ FT PROPERTY LINE PROPOSED FIFTH FLOOR PLAN: (AREA OF EXISTING BUILDING @ FIFTH FLOOR =  $0'-0" \times 0'-0" = 0 \text{ SQ. FT.}$ ) + (AREA OF PROPOSED EXTENSION =  $46'-0\frac{11}{16}$ " X 20'-0" = 921.1286 SQ. FT.) PROPOSED FIFTH FLOOR AREA AND LOT COVERAGE = 921.1286 SQ. FT.

1STFLOOR  $(57'-1" \times 20'-0" + (2'-5" \times 5'-2")/2 + (2'-5" \times 5'-2")/2 + 2'-5" \times 7'-8" + 14.5' \times 9.6') = 1311.8806 \text{ SF}$ 

2ND FLOOR (57'-1" X 20'-0" + (2'-1" X 5'-2")/2 + (2'-1" X 5'-2")/2 + 2'-1" X 7'-8" + 14.5' X 9.6') = 1307.6028 SF  $3RD FLOOR \qquad (57'-1" \ X \ 20'-0" + (2'-1" \ X \ 5'-2")/2 + (2'-1" \ X \ 5'-2")/2 + 2'-1" \ X \ 7'-8" + 14.5' \ X \ 9.6') \qquad = \qquad 1307.6028 \ SF$ 

= 0 SF (1349.8SF)

= 1234.35 SF

= 990.78 SF

= 1230.07 SF

= 1168.4 SF

= 921.1286 SF

= 5544.7286 SF

4TH FLOOR (57'-1" X 20'-0" + (2'-1" X 5'-2")/2 + (2'-1" X 5'-2")/2 + 2'-1" X 7'-8")

= 0 SF (1345.7625 SF GROSS)

= 1168.4028 SF

= 5095.489 SF

FLOOR AREA CALCULATIONS (EXISTING)

FLOOR AREA CALCULATIONS (PROPOSED)

CELLAR FLOOR

TOTAL

CELLAR FLOOR

1STFLOOR

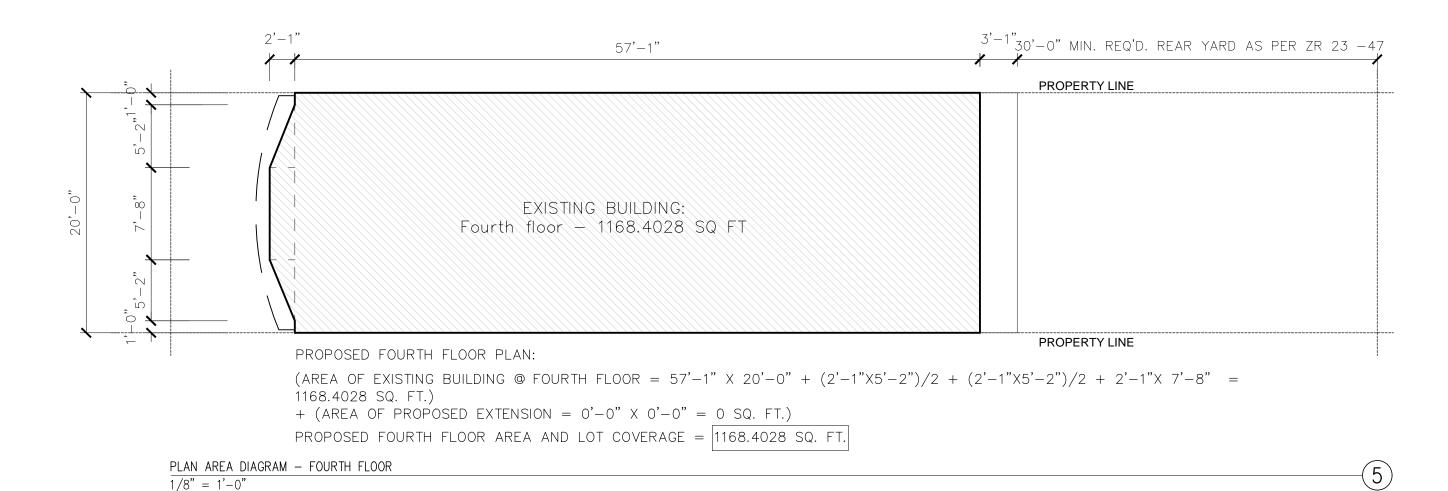
2ND FLOOR

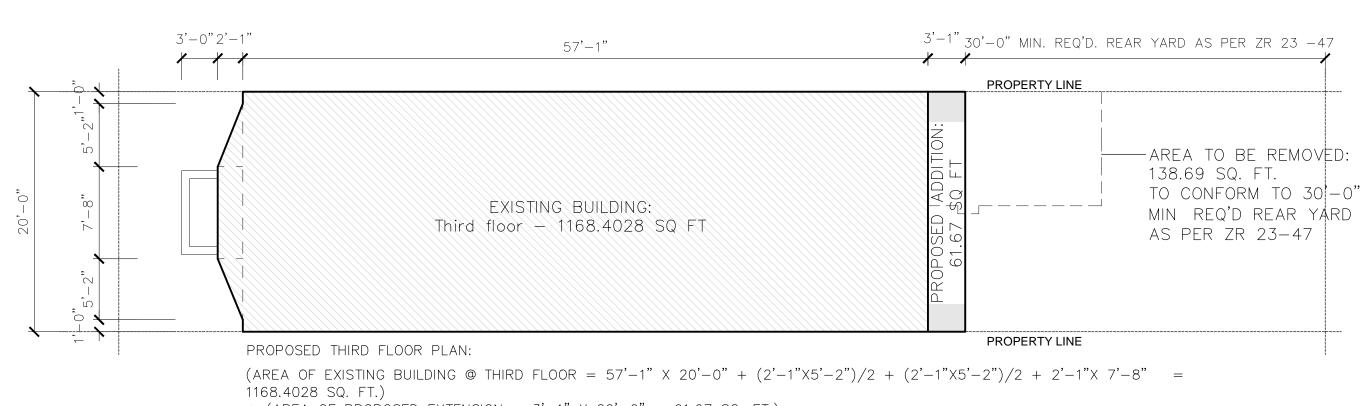
3RD FLOOR

4TH FLOOR

5TH FLORR

TOTAL





+ (AREA OF PROPOSED EXTENSION =  $3'-1" \times 20'-0" = 61.67 \text{ SQ. FT.}$ )

PROPOSED THIRD FLOOR AREA AND LOT COVERAGE = 1230.0728 SQ. FT.

PLAN AREA DIAGRAM — THIRD FLOOR 1/8" = 1'-0"

PLAN AREA DIAGRAM — FIFTH FLOOR

1/8" = 1'-0"

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ISSUES AND REVISIONS  DATE ISSUE 10.17.18 DOB REVIEW	Pf	ROPOSED ADDITION
DATE ISSUE	P	ERMITTED OBSTRUCTION
	ISSUES AND RE	VISIONS
10.17.18 DOB REVIEW	DATE	ISSUE
	10.17.18	DOB REVIEW

LEGEND

EXISTING BUILDING

PROJECT No: DRAWING BY: YW LPC118.00

LI RESIDENCE

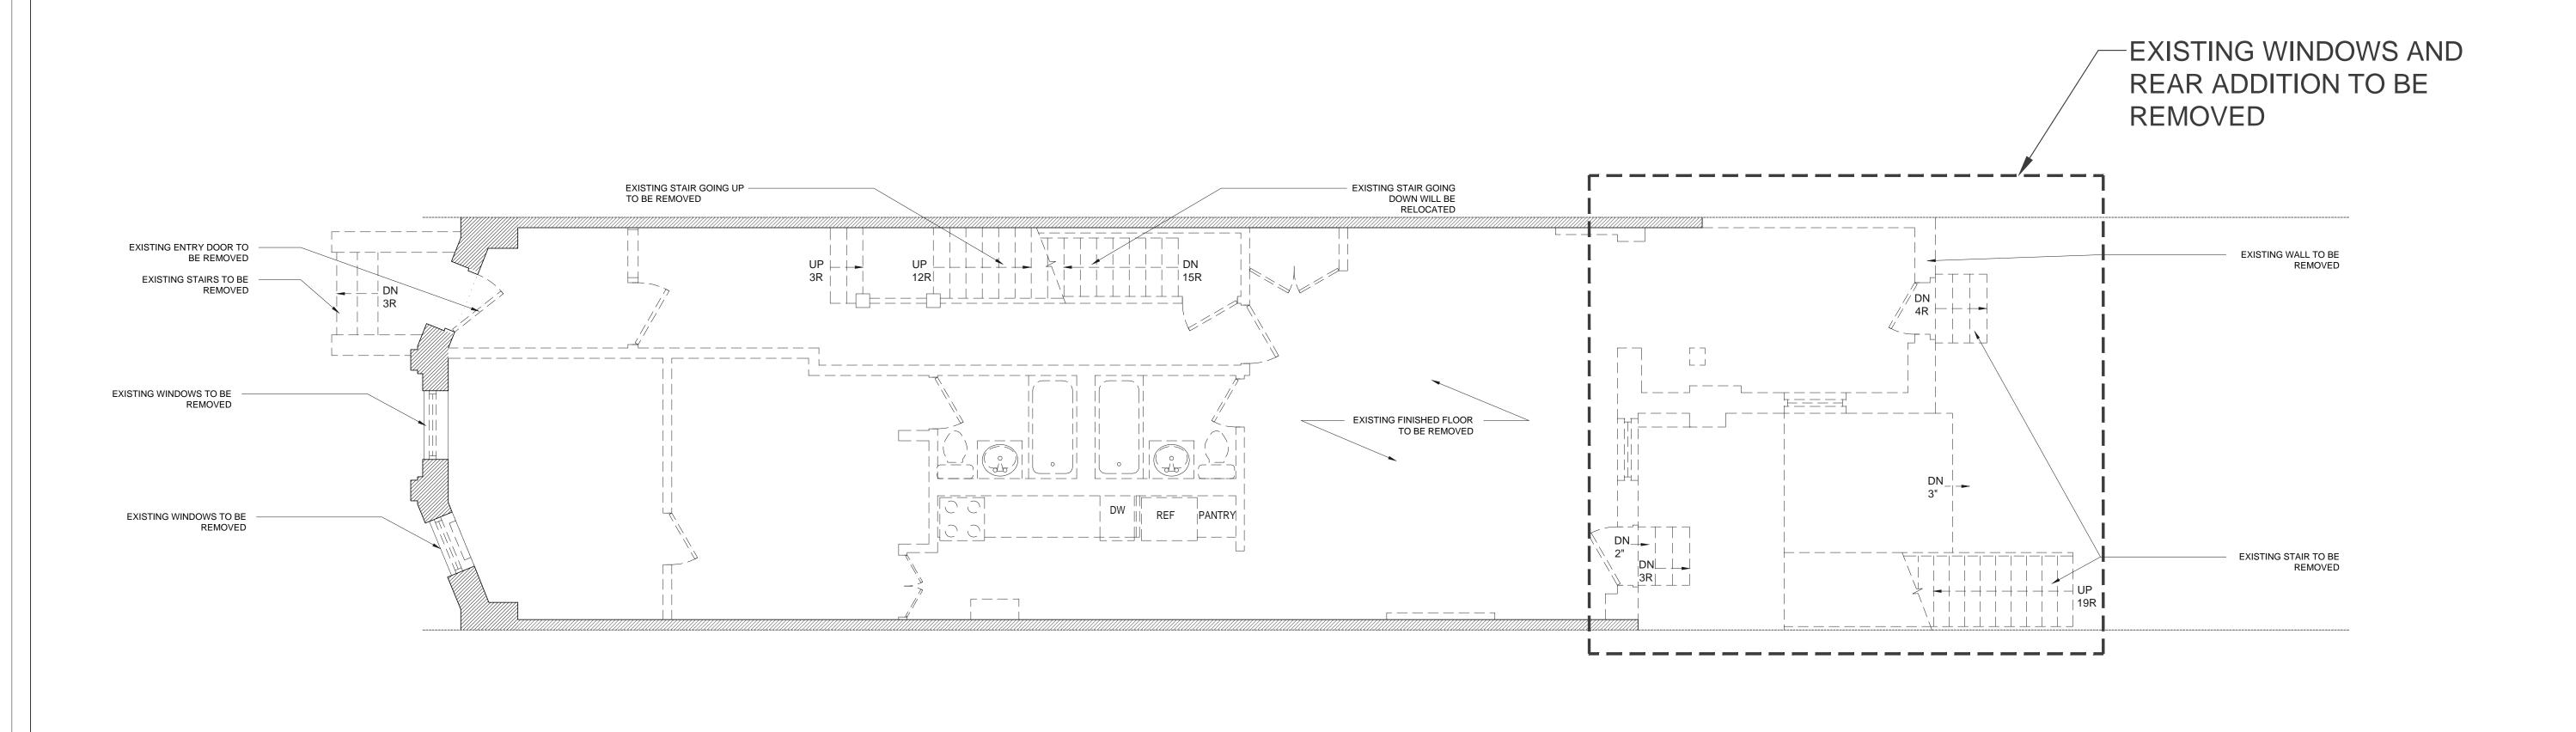
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PLAN AREA DIAGRAM

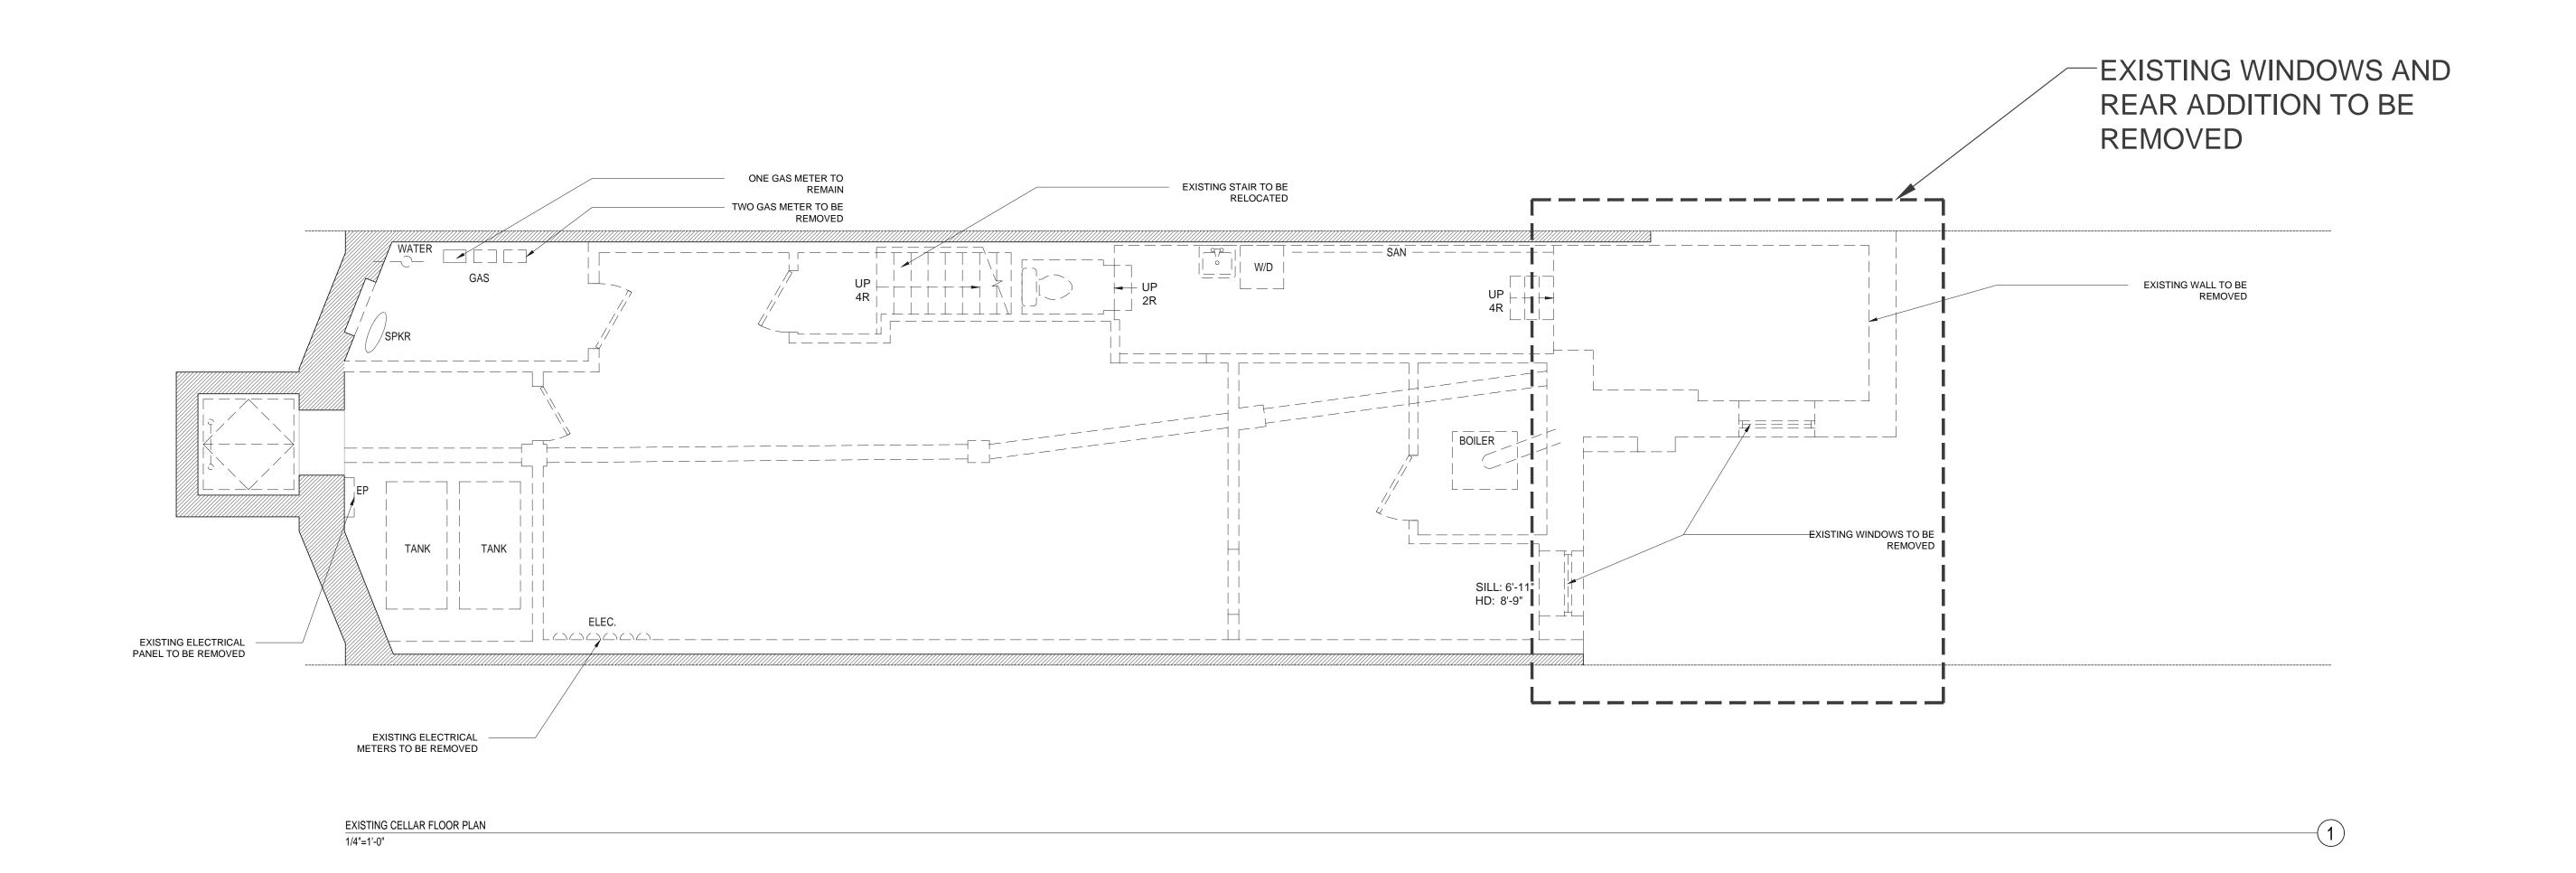
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EXISTING FIRST FLOOR PLAN

1/4"=1'-0"



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EXISTING CONSTRUCTION

WALLS TO BE REMOVED

NEW CONSTRUCTION

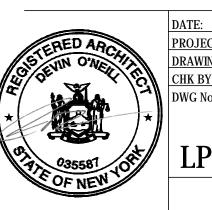
PROPERTY LINE

DATE	ISSUE
10.17.18	DOB REVIEW

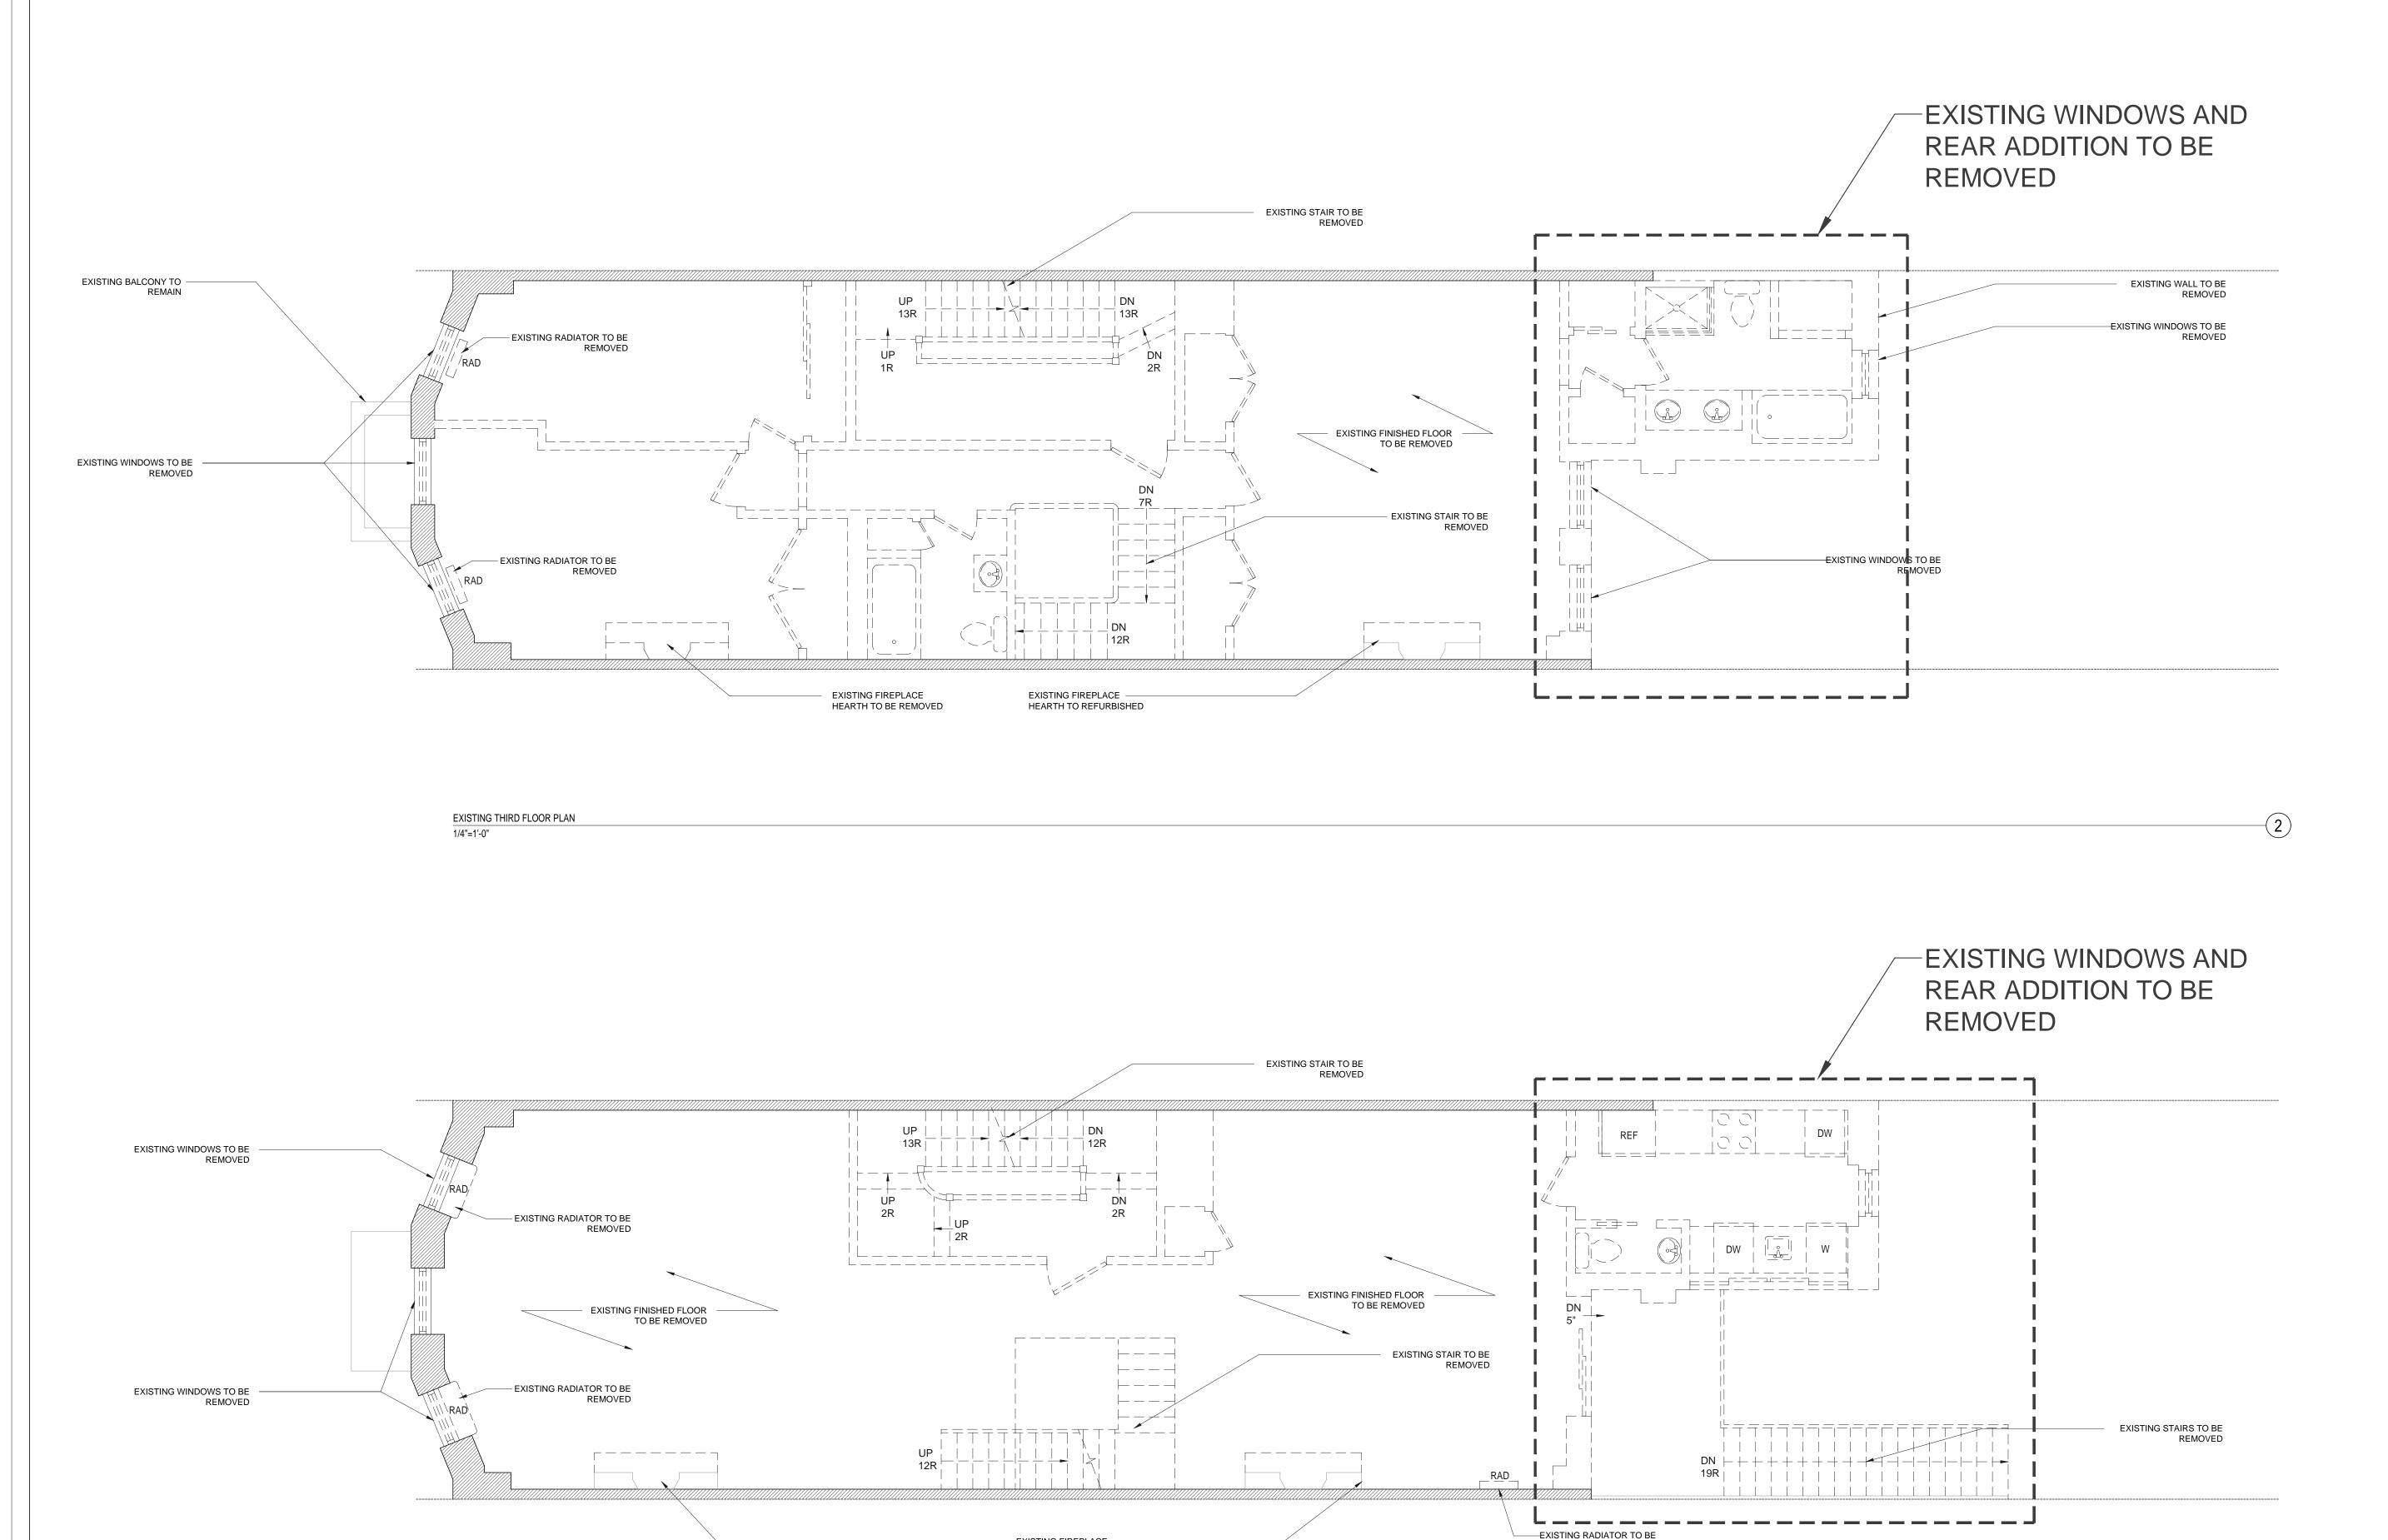
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EXISTING FLOOR PLANS CELLAR AND FIRST FLOORS



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EXISTING FIREPLACE

TO REFURBISHED

EXISTING SECOND FLOOR PLAN

1/4"=1'-0"

REMOVED

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LEGEND

EXISTING CONSTRUCTION

WALLS TO BE REMOVED

NEW CONSTRUCTION

PROPERTY LINE

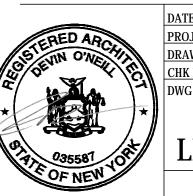
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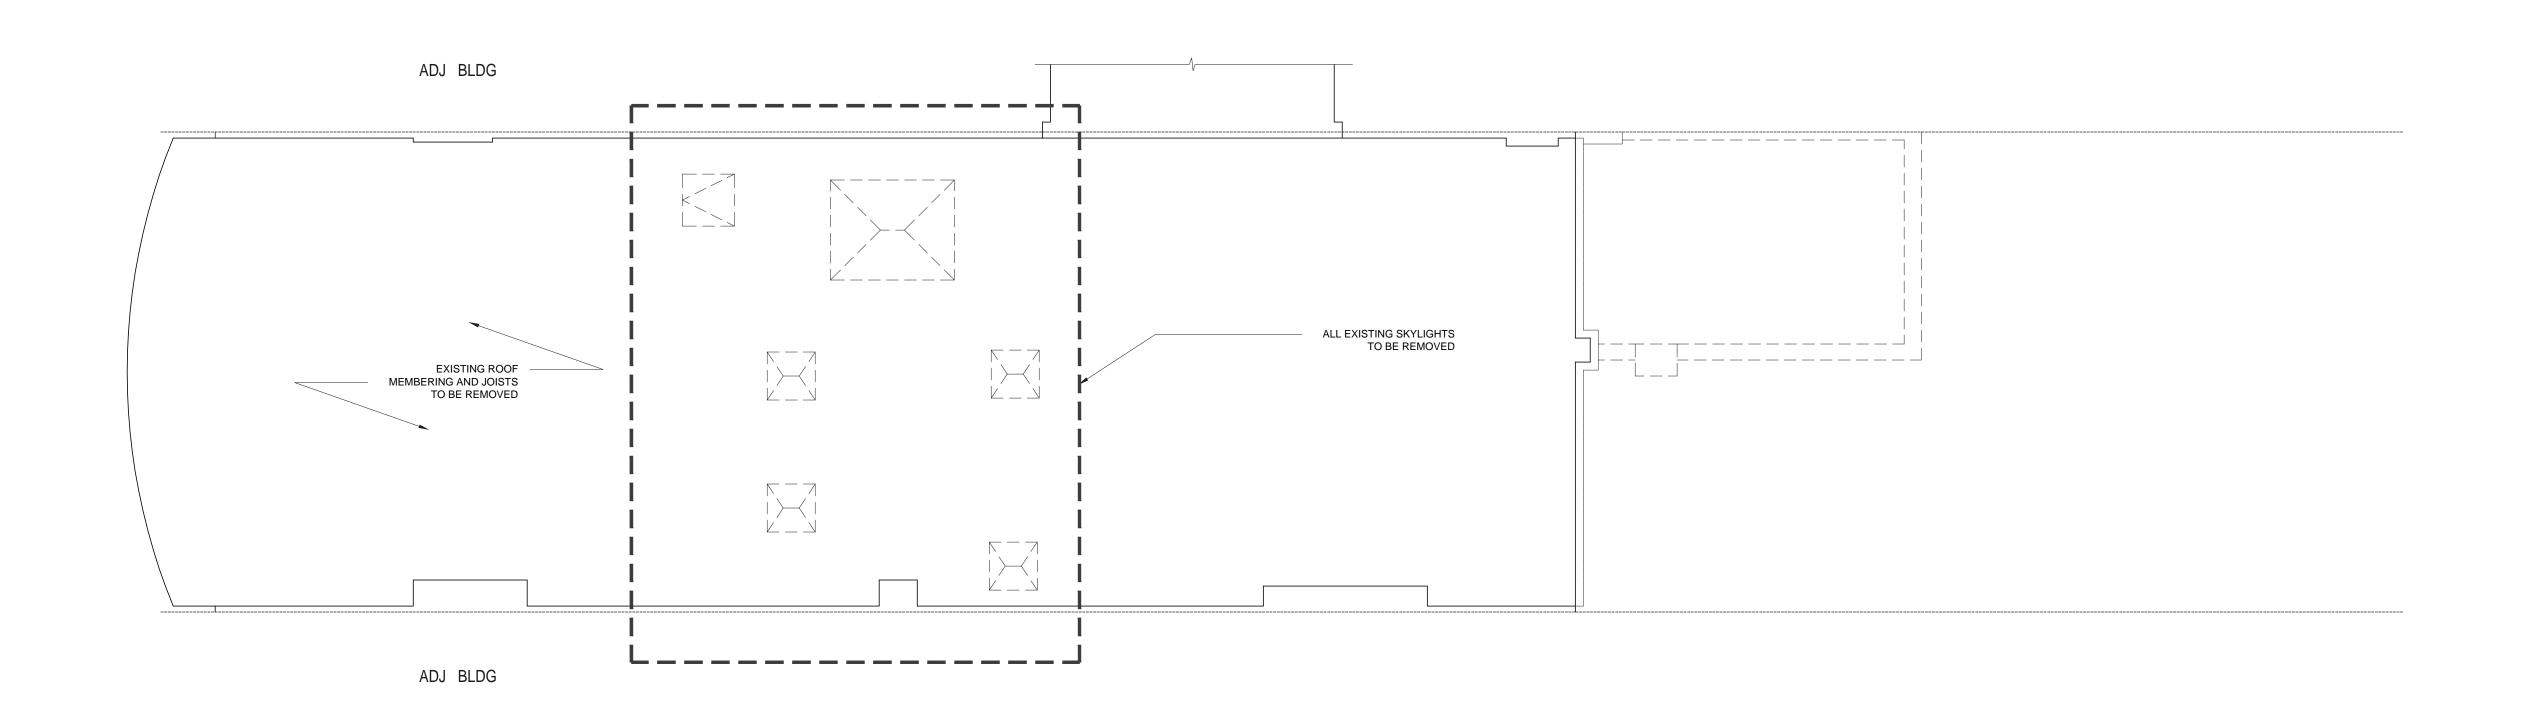
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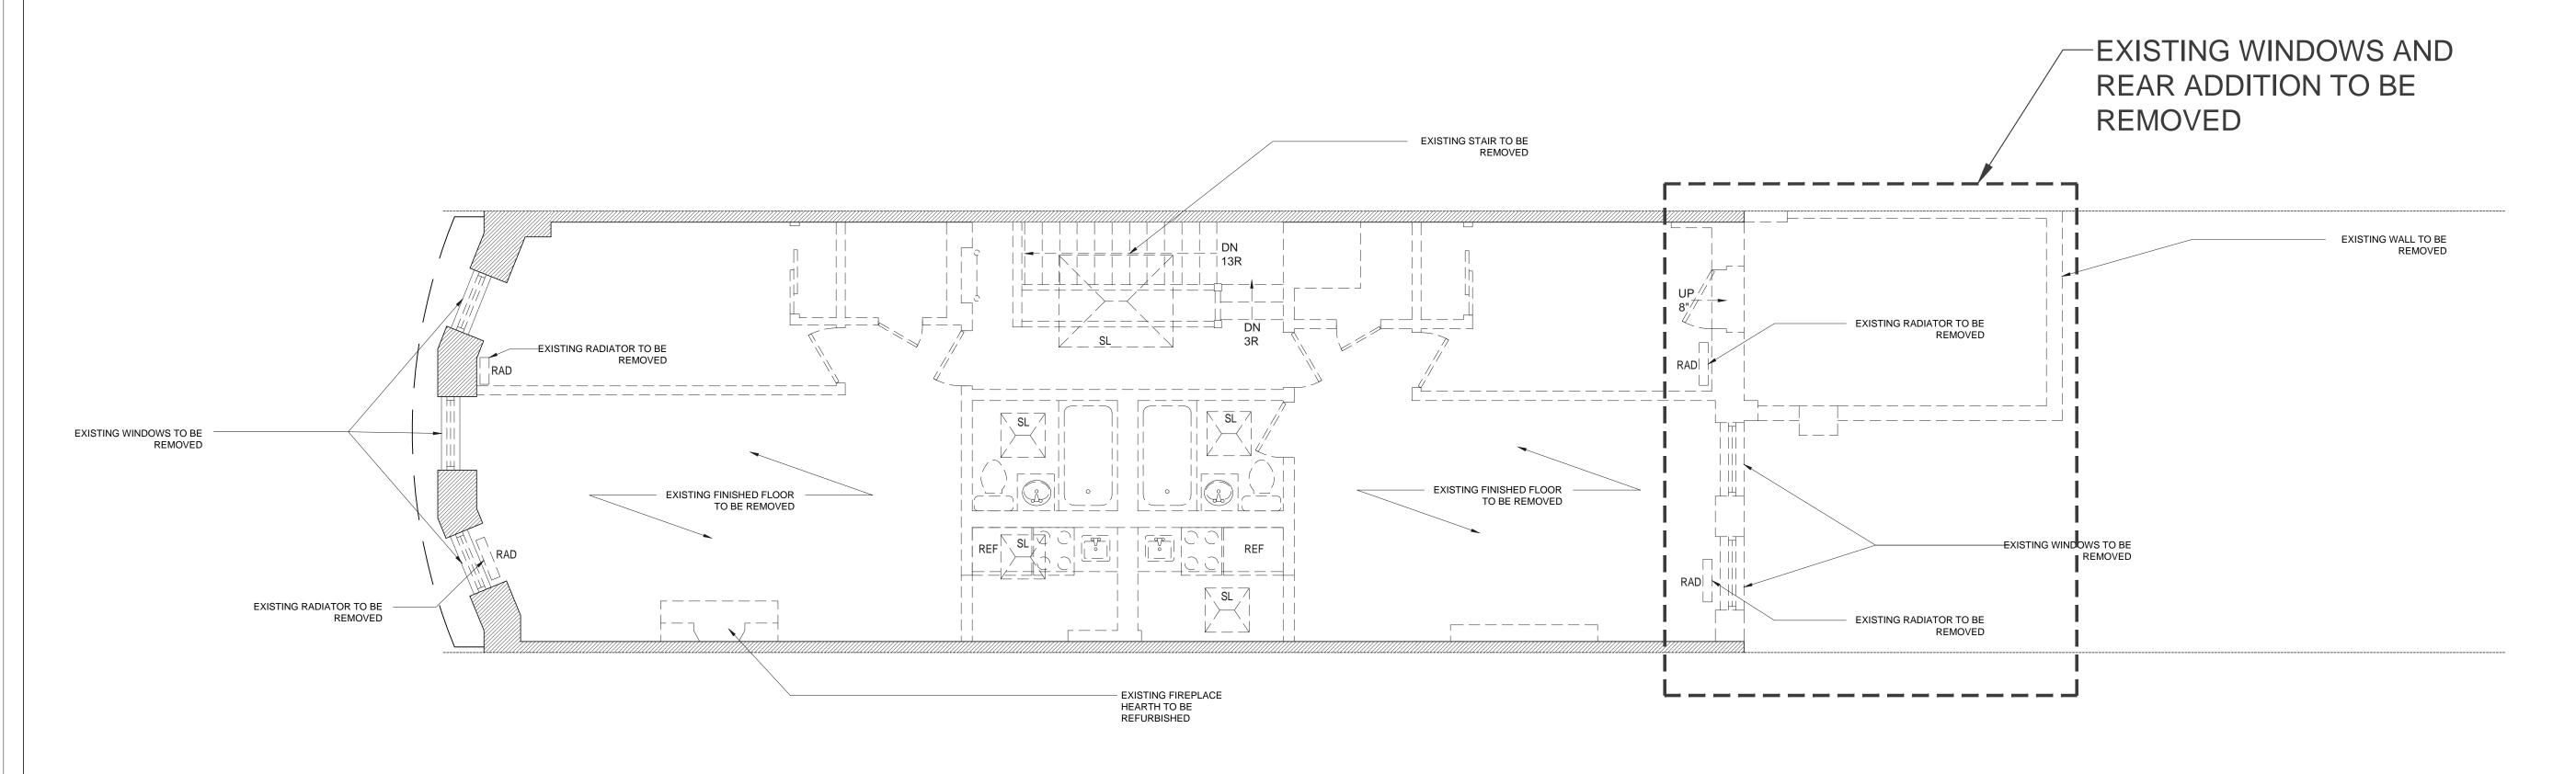
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EXISTING FLOOR PLANS SECOND AND THIRD FLOORS



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EXISTING ROOF PLAN

1/4"=1'-0"

EXISTING FOURTH FLOOR PLAN
1/4"=1'-0"

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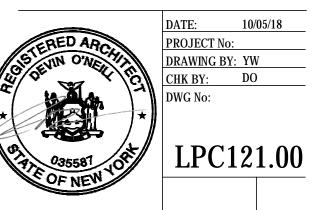
LEGEND	
	EXISTING CONSTRUCTION
====	WALLS TO BE REMOVED
	NEW CONSTRUCTION
	PROPERTY LINE

ISSUES AND RE	VISIONS
DATE	ISSUE
10.17.18	DOB REVIEW

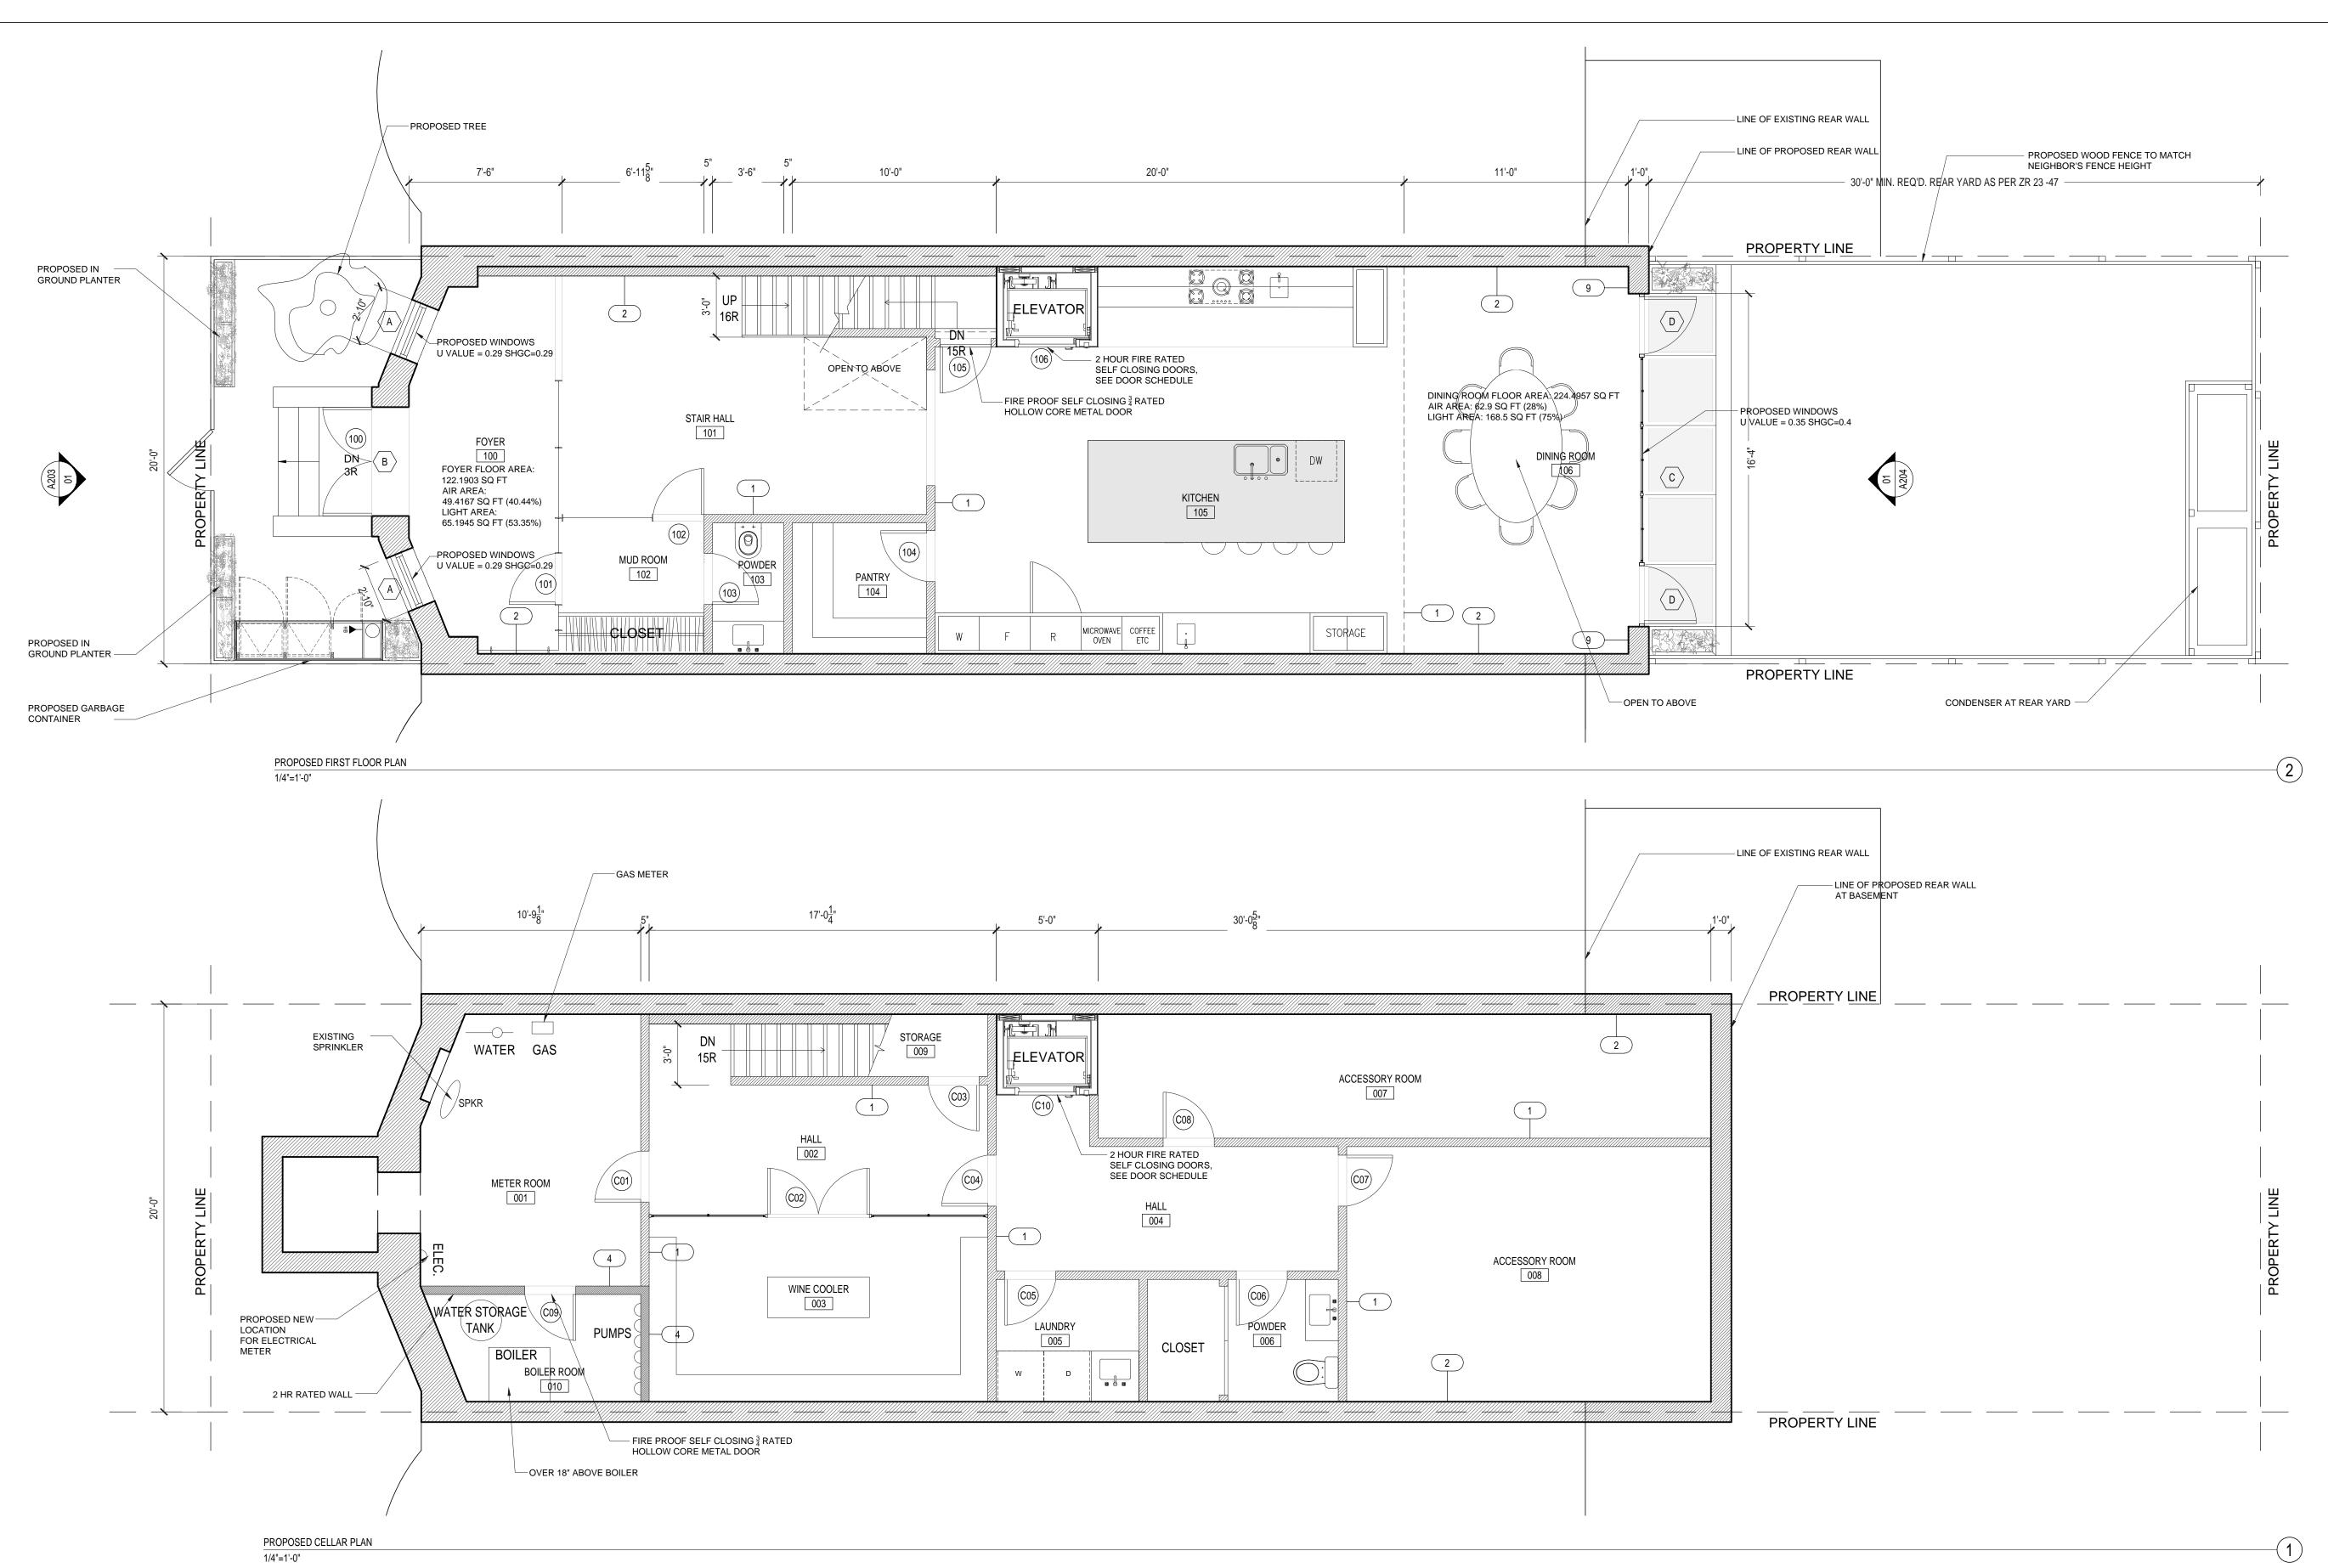
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EXISTING FLOOR PLANS FOURTH AND FIFTH FLOORS



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DOOR SCHEDULE DATE: 10.05.2018

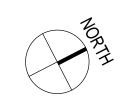
**LI Residence** 121 W 88TH ST NEW YORK, NY 10024

DOOR	OPERATION	FRAME SIZE (WxH)	THICKNESS	DOOR TYPE	HARDWARE	REMARKS
BASEMENT						
B01	SWING	2'6" x 7'	1-3/4"			
B02	SWING	2'6" x 7'	1-3/4"			
B03	SWING	2'6" x 7'	1-3/4"			
B04	SWING	2'6" x 7'	1-3/4"			
B05	SWING	2'6" x 7'	1-3/4"			
B06	SWING	2'6" x 7'	1-3/4"			
B07	SWING	2'6" x 7'	1-3/4"			
B08	SWING	2'6" x 7'	1-3/4"			
B09	SWING	2'6" x 7'	1-3/4"			FIRE PROOF SELF CLOSING 3/4  RATED  HOLLOW CORE METAL DOOR

B10	SWING	2'10" x 7'	1-3/4"	2 HOUR FIRE RATED SELF CLOSING DOORS
RST FLOOR				
101	POCKET	2'6" x 7'	1-3/4"	
102	POCKET	2'6" x 7'	1-3/4"	
103	SWING	2'6" x 7'	1-3/4"	
104	SWING	2'6" x 7'	1-3/4"	
105	SWING	2'6" x 7'	1-3/4"	
106	SWING	2'6" x 7'	1-3/4"	FIRE PROOF SELF CLOSING 3/4 RATED HOLLOW CORE METAL DOOR
107	SWING	2'10" x 7'	1-3/4"	2 HOUR FIRE RATED SELF CLOSING DOORS

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LEGEND	
	EXISTING TO REMAIN

WALLS TO BE REMOVED
NEW CONSTRUCTION

PROPERTY LINE	

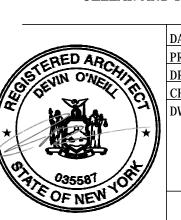
2HR FIRE RATED WALL

DATE	ISSUE
10.17.18	DOB REVIEW

PROJECT:

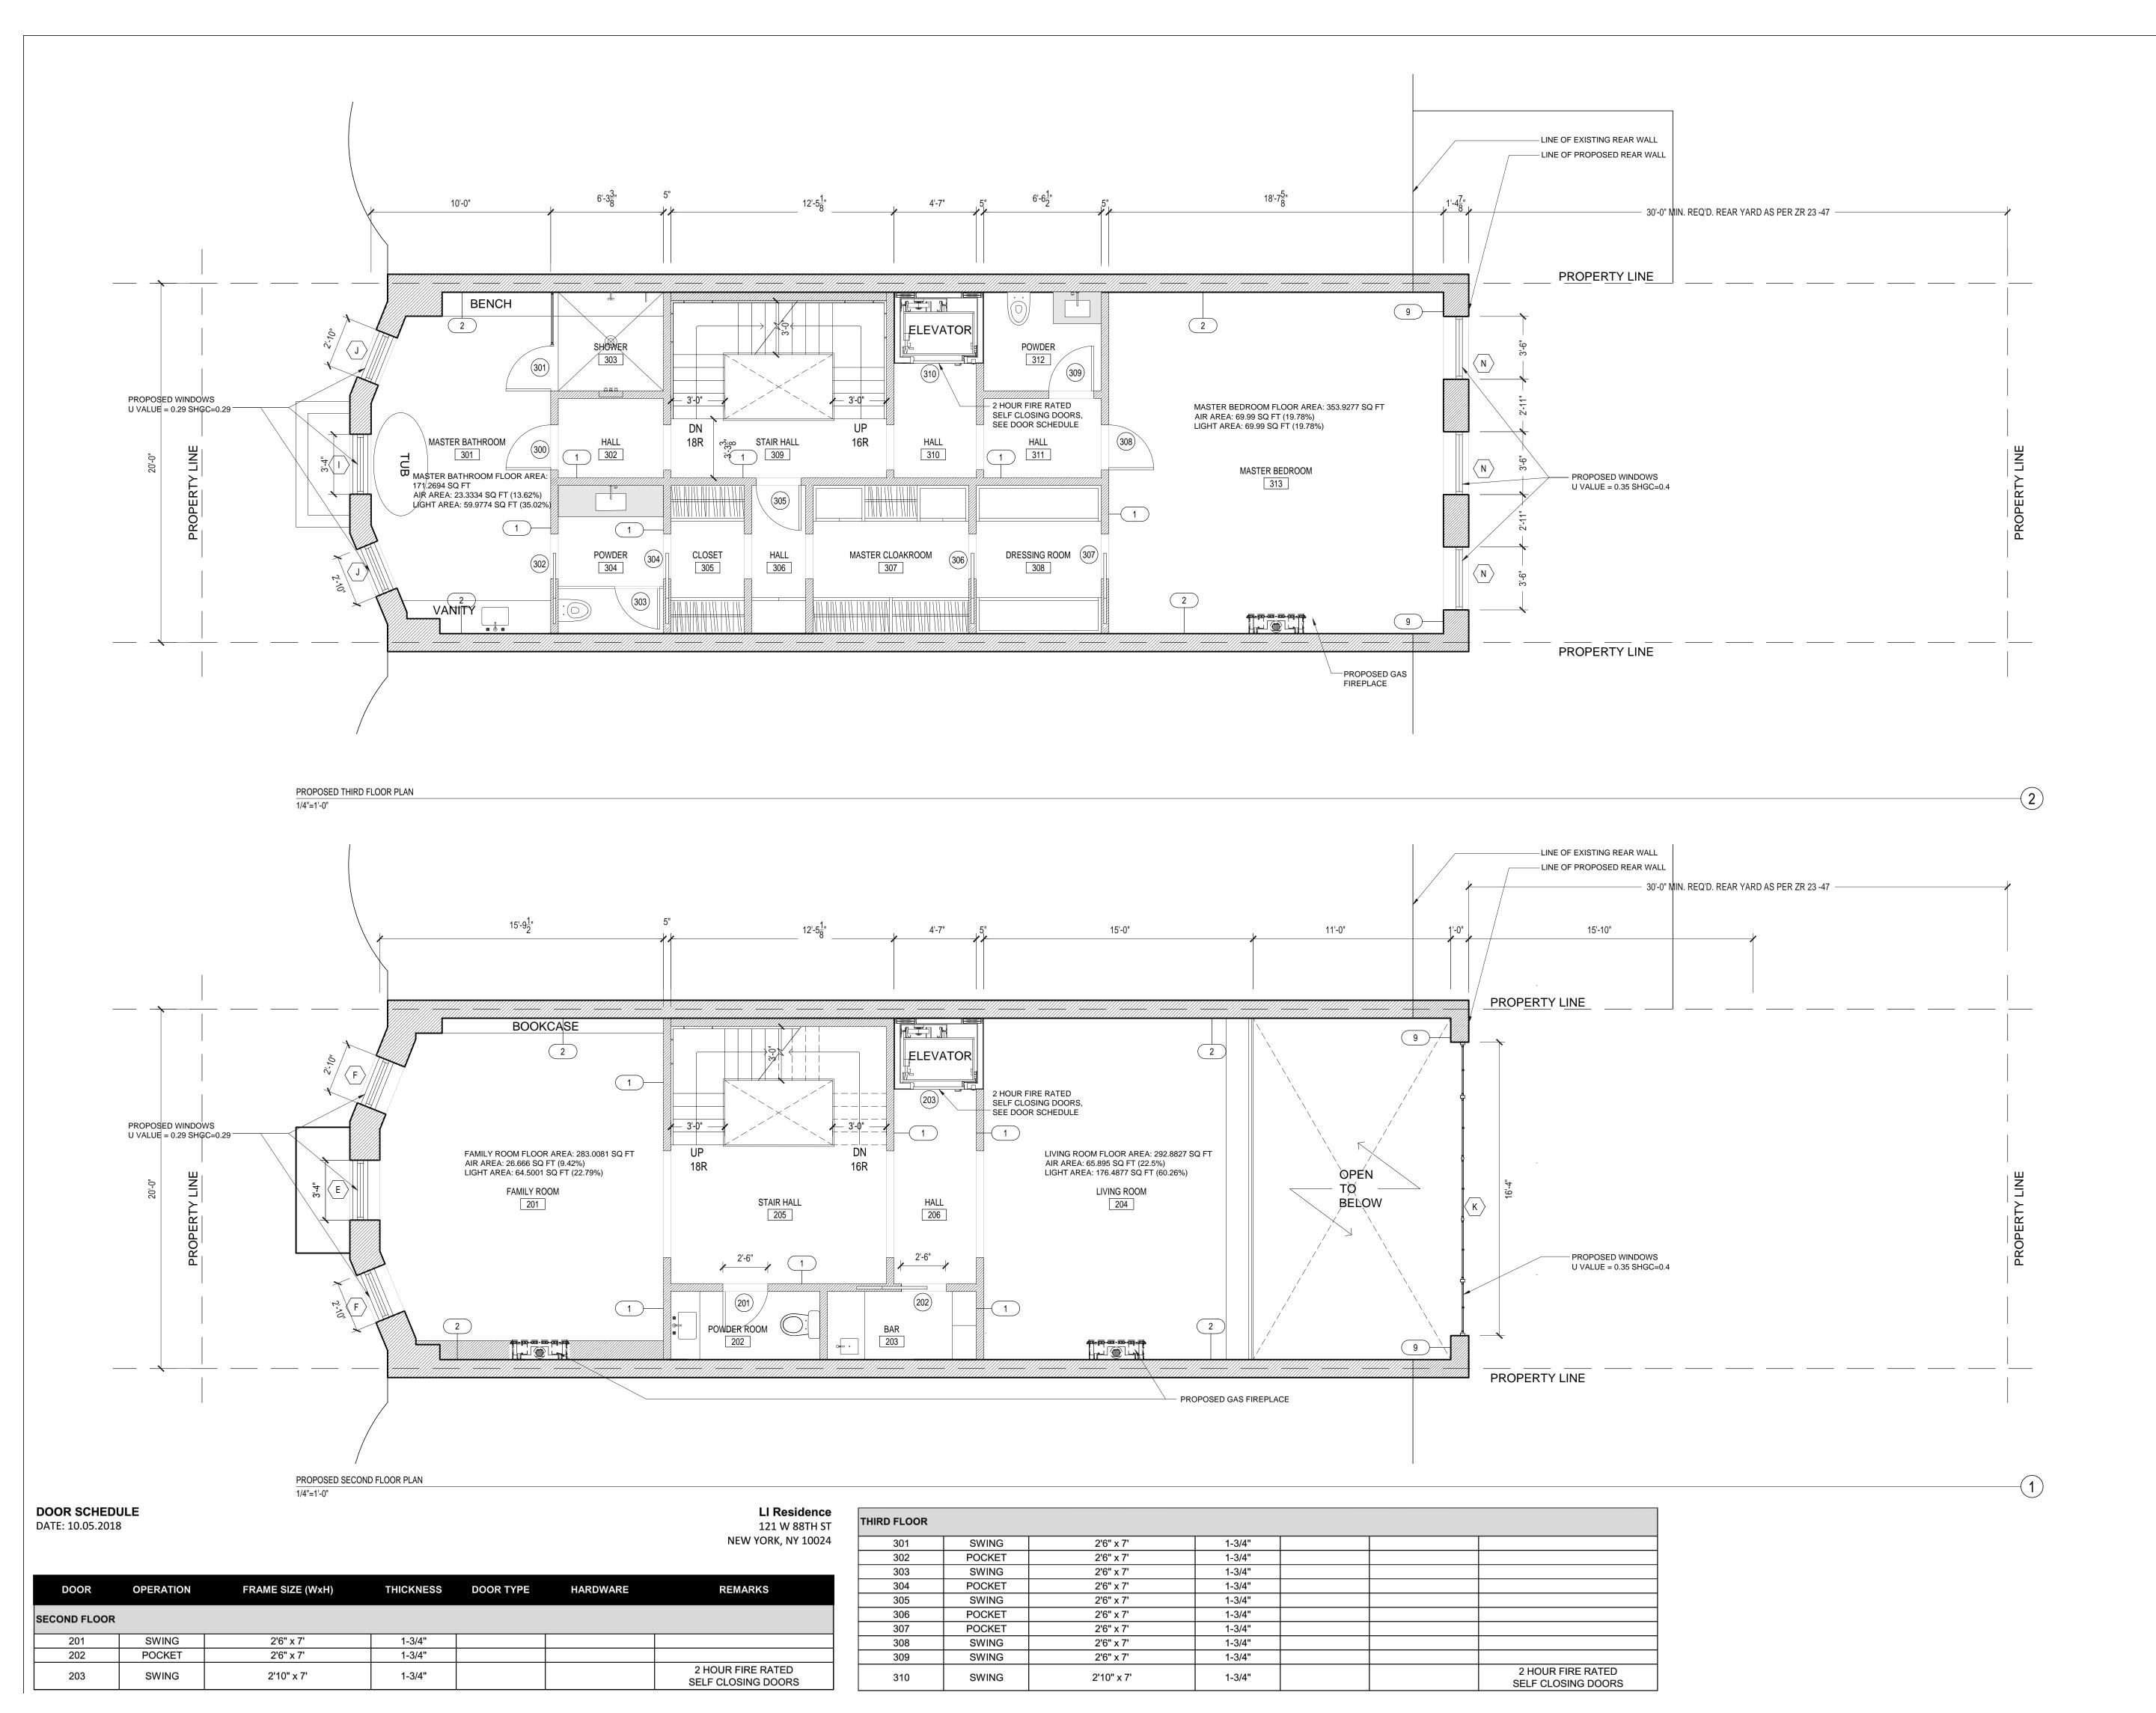
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PROPOSED FLOOR PLANS CELLAR AND FIRST FLOOR

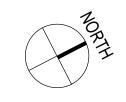


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LEGEND	
	FYICTING

EXISTING TO RE

WALLS TO BE REMOV

NEW CONSTRUCTION

PROPERTY LINE

2HR FIRE RATED WALL

ISSUES AND REVISIONS

DATE	ISSUE
10.17.18	DOB REVIEW

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PROPOSED FLOOR PLANS SECOND AND THIRD FLOORS



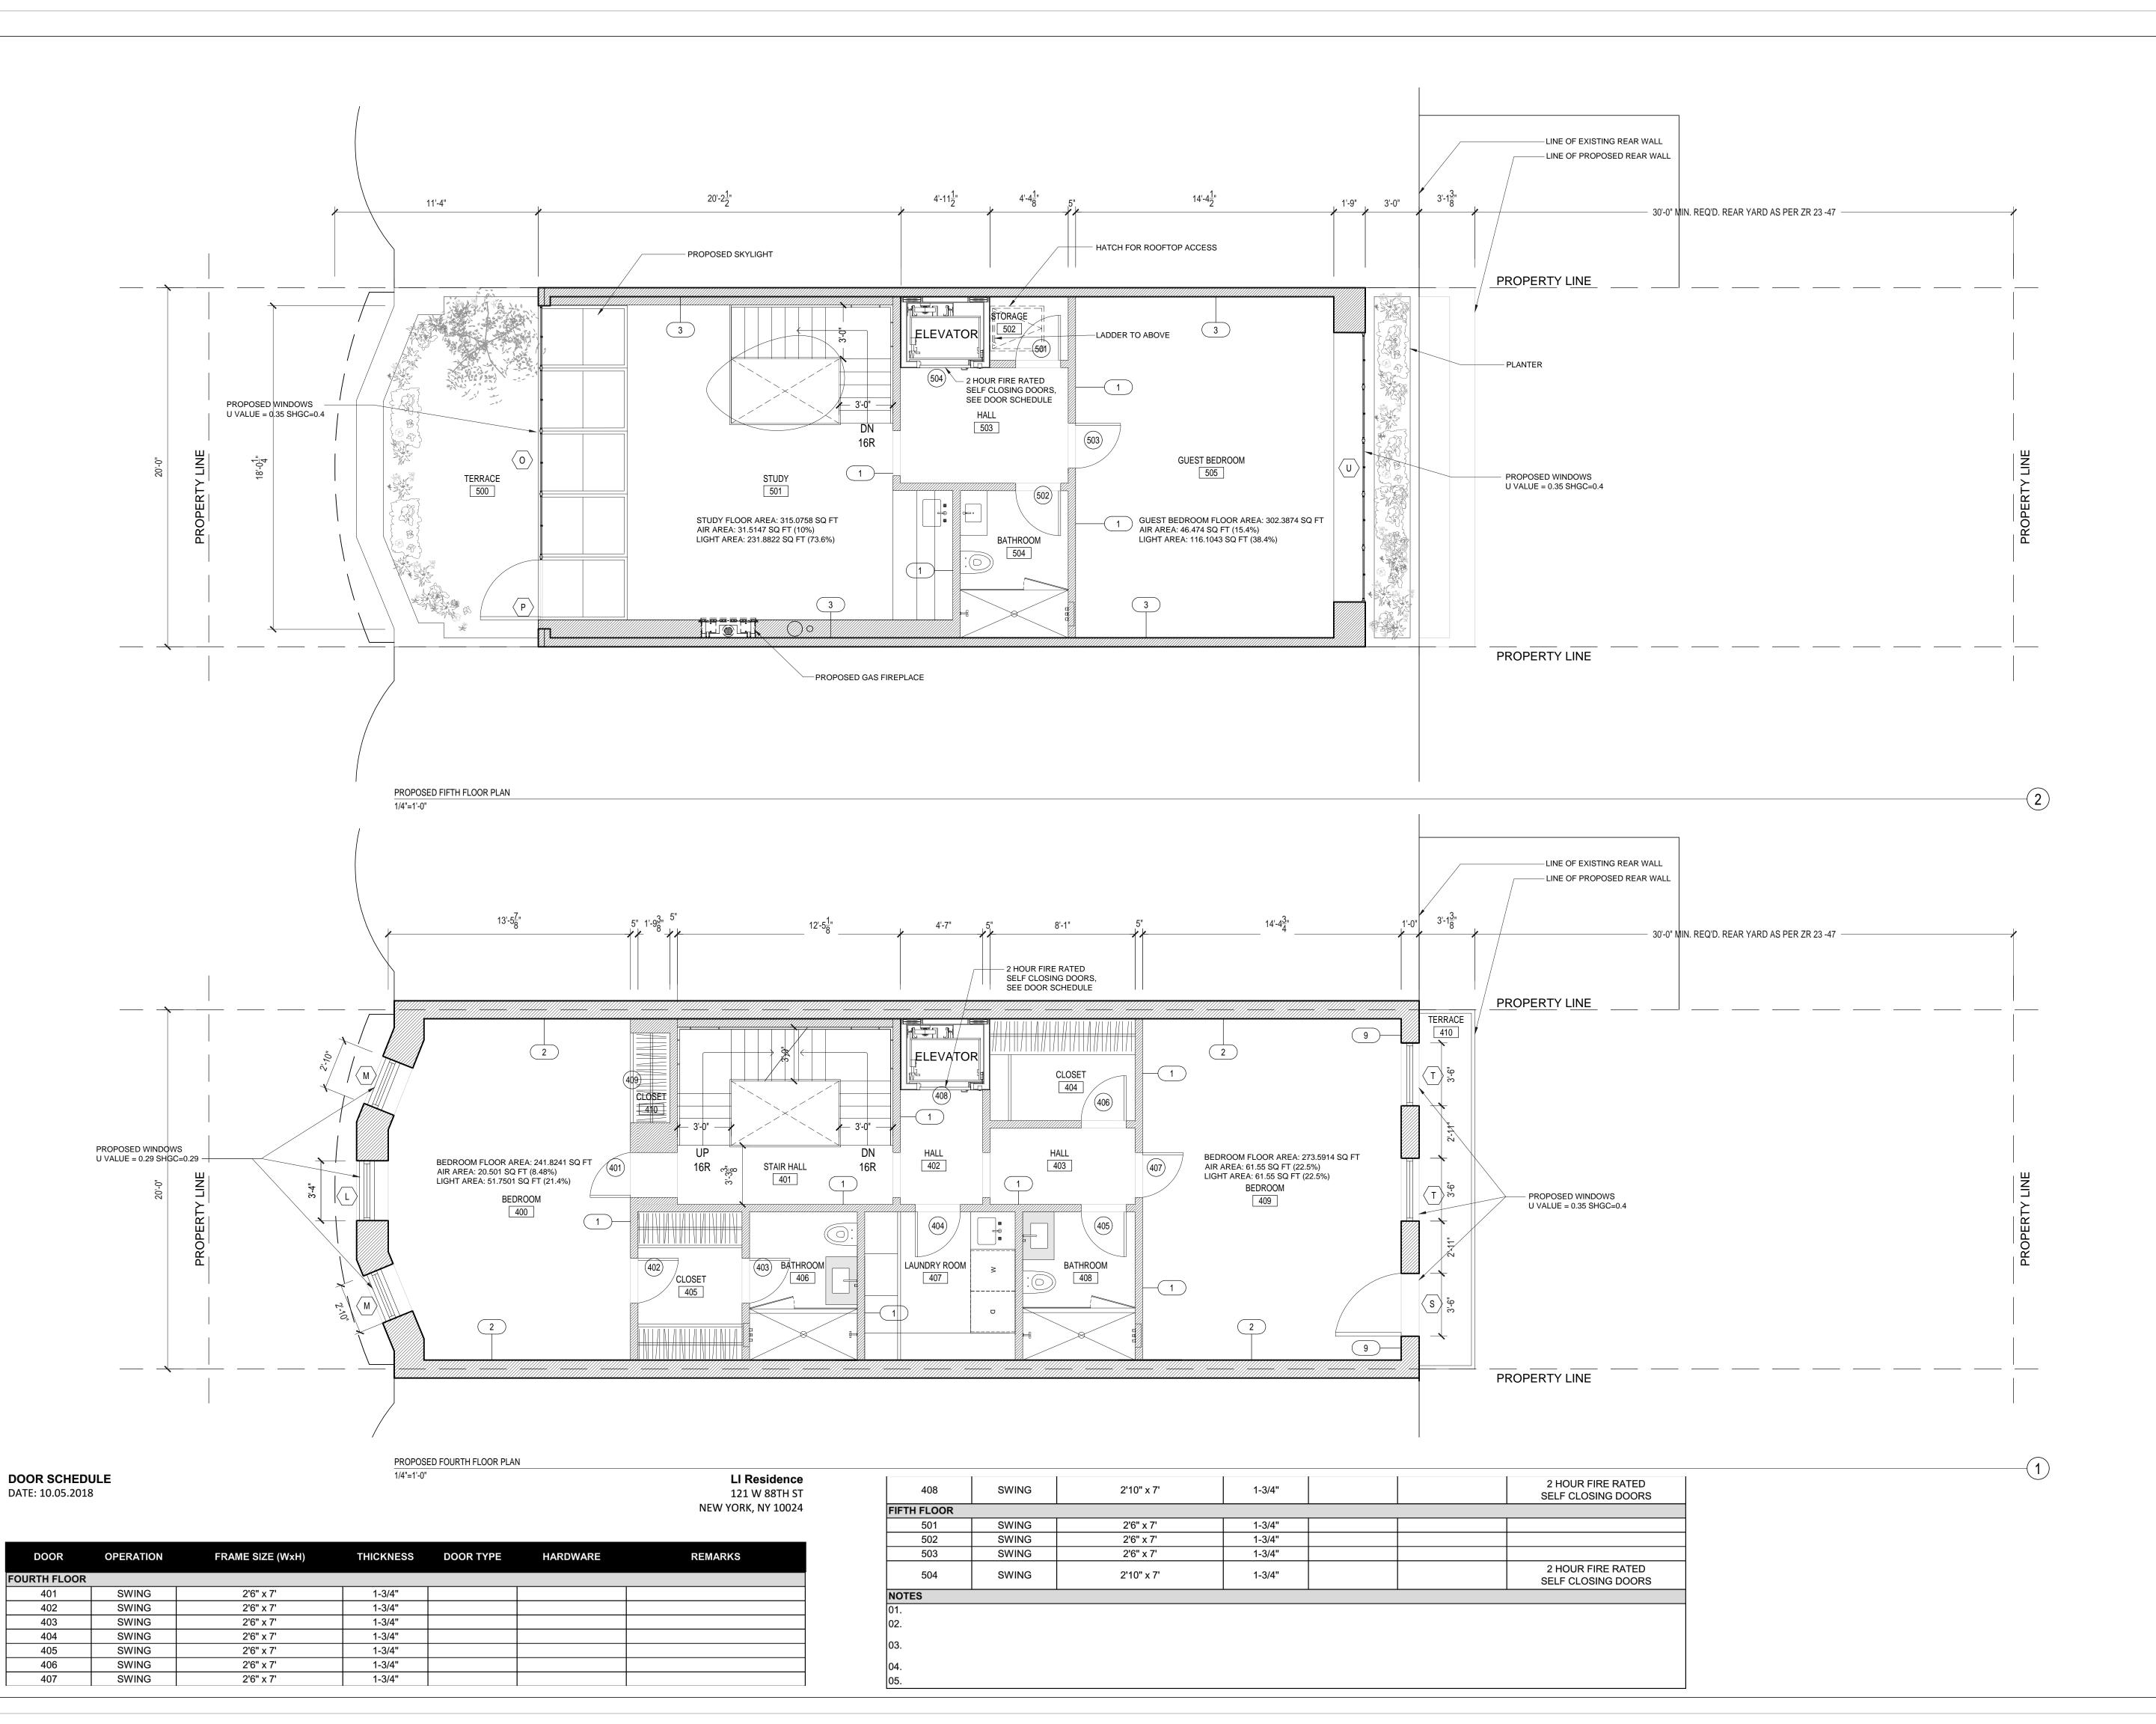
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DRAWING BY: YW

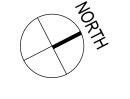
CHK BY: DO

DWG No:

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LEGEND

EXISTING TO REMAIN

WALLS TO BE REMOVED NEW CONSTRUCTION

PROPERTY LINE

2HR FIRE RATED WALL

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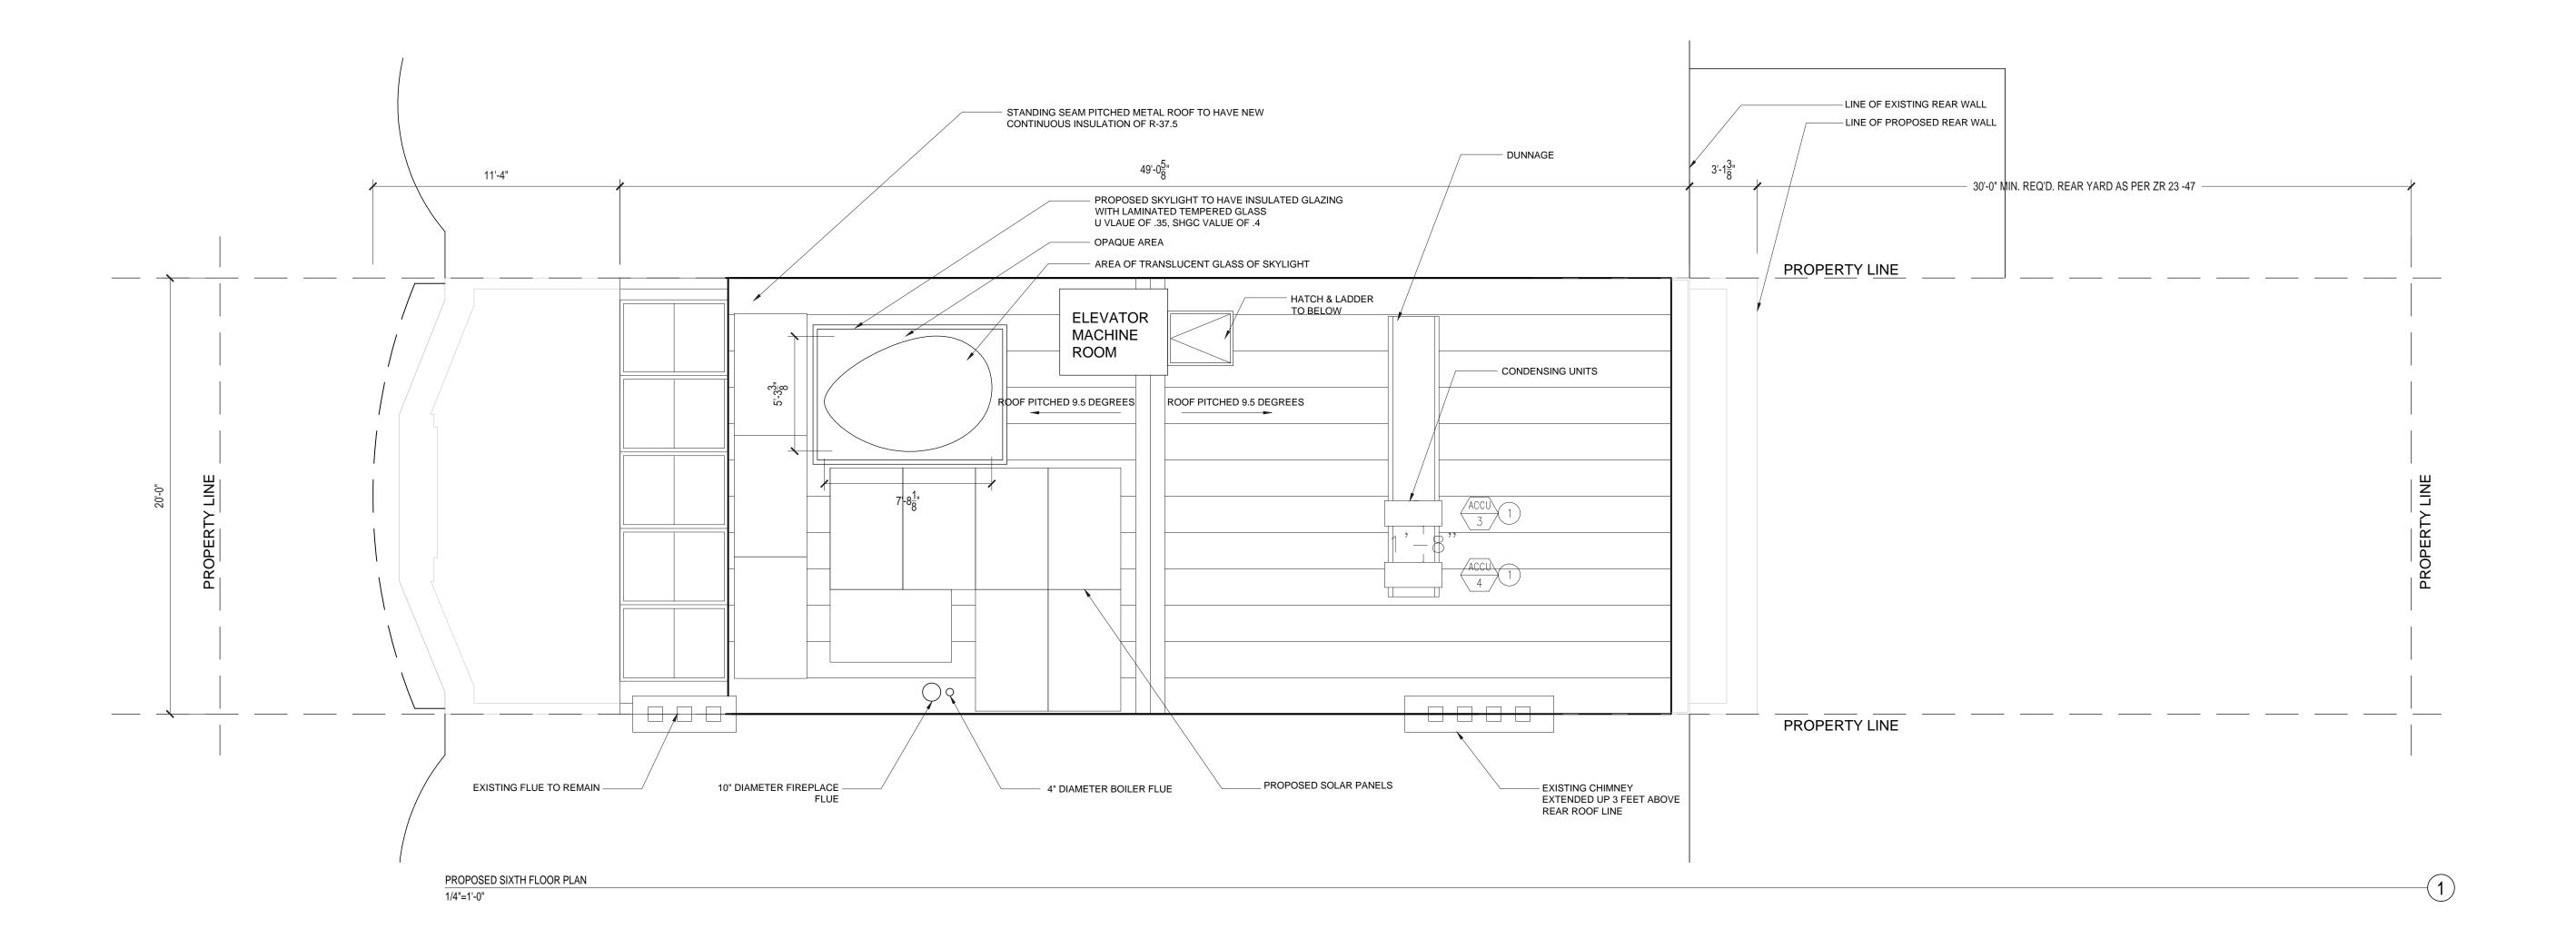
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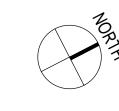
PROPOSED FLOOR PLANS FOURTH AND FIFTH FLOORS



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WALLS TO BE REMOVED

NEW CONSTRUCTION

PROPERTY LINE

2HR FIRE RATED WALL

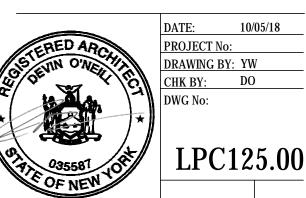
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PROPOSED ROOF PLAN



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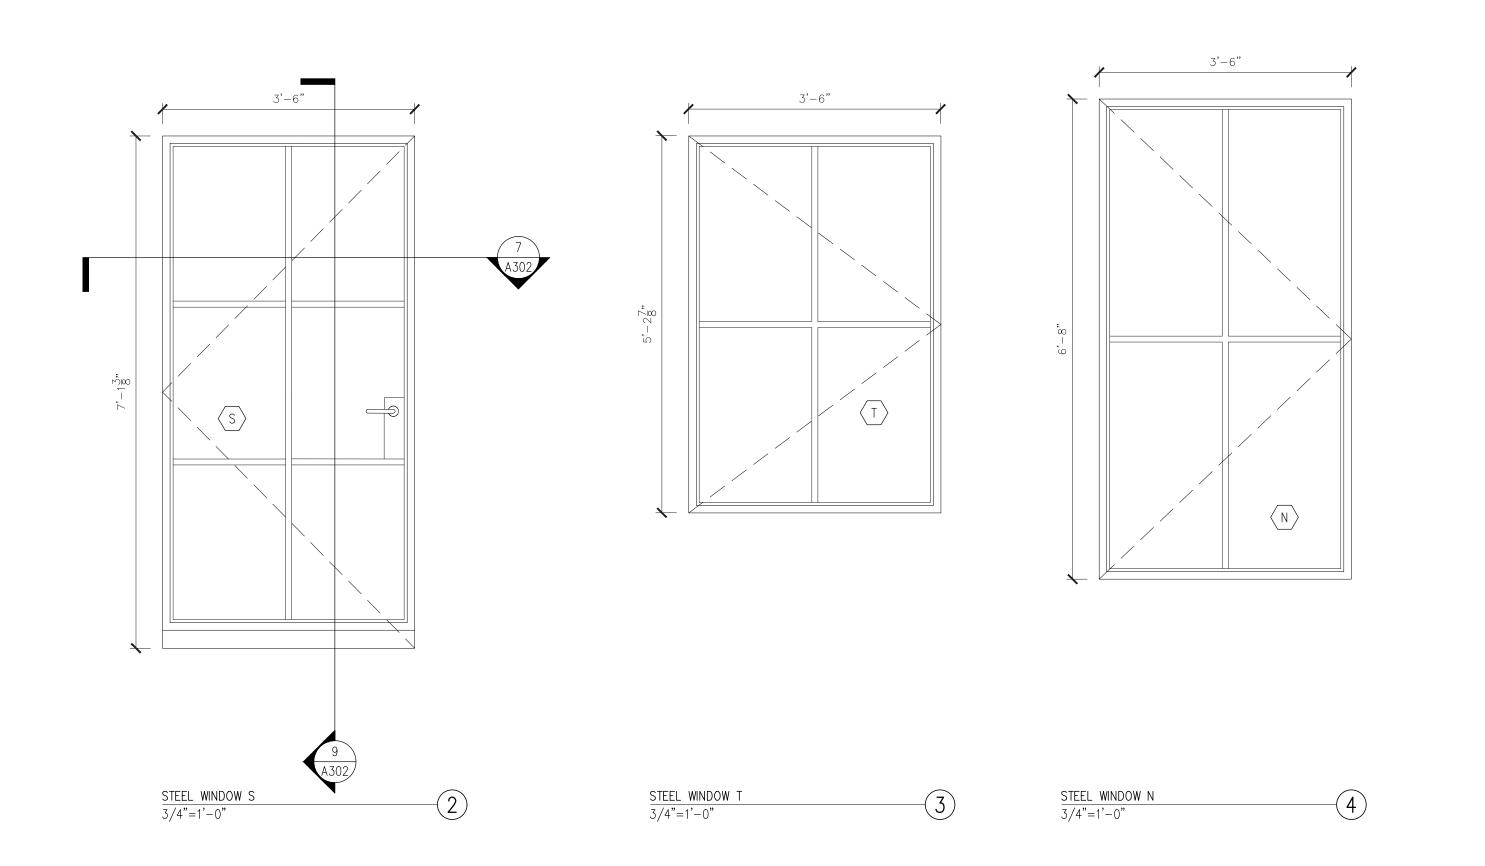
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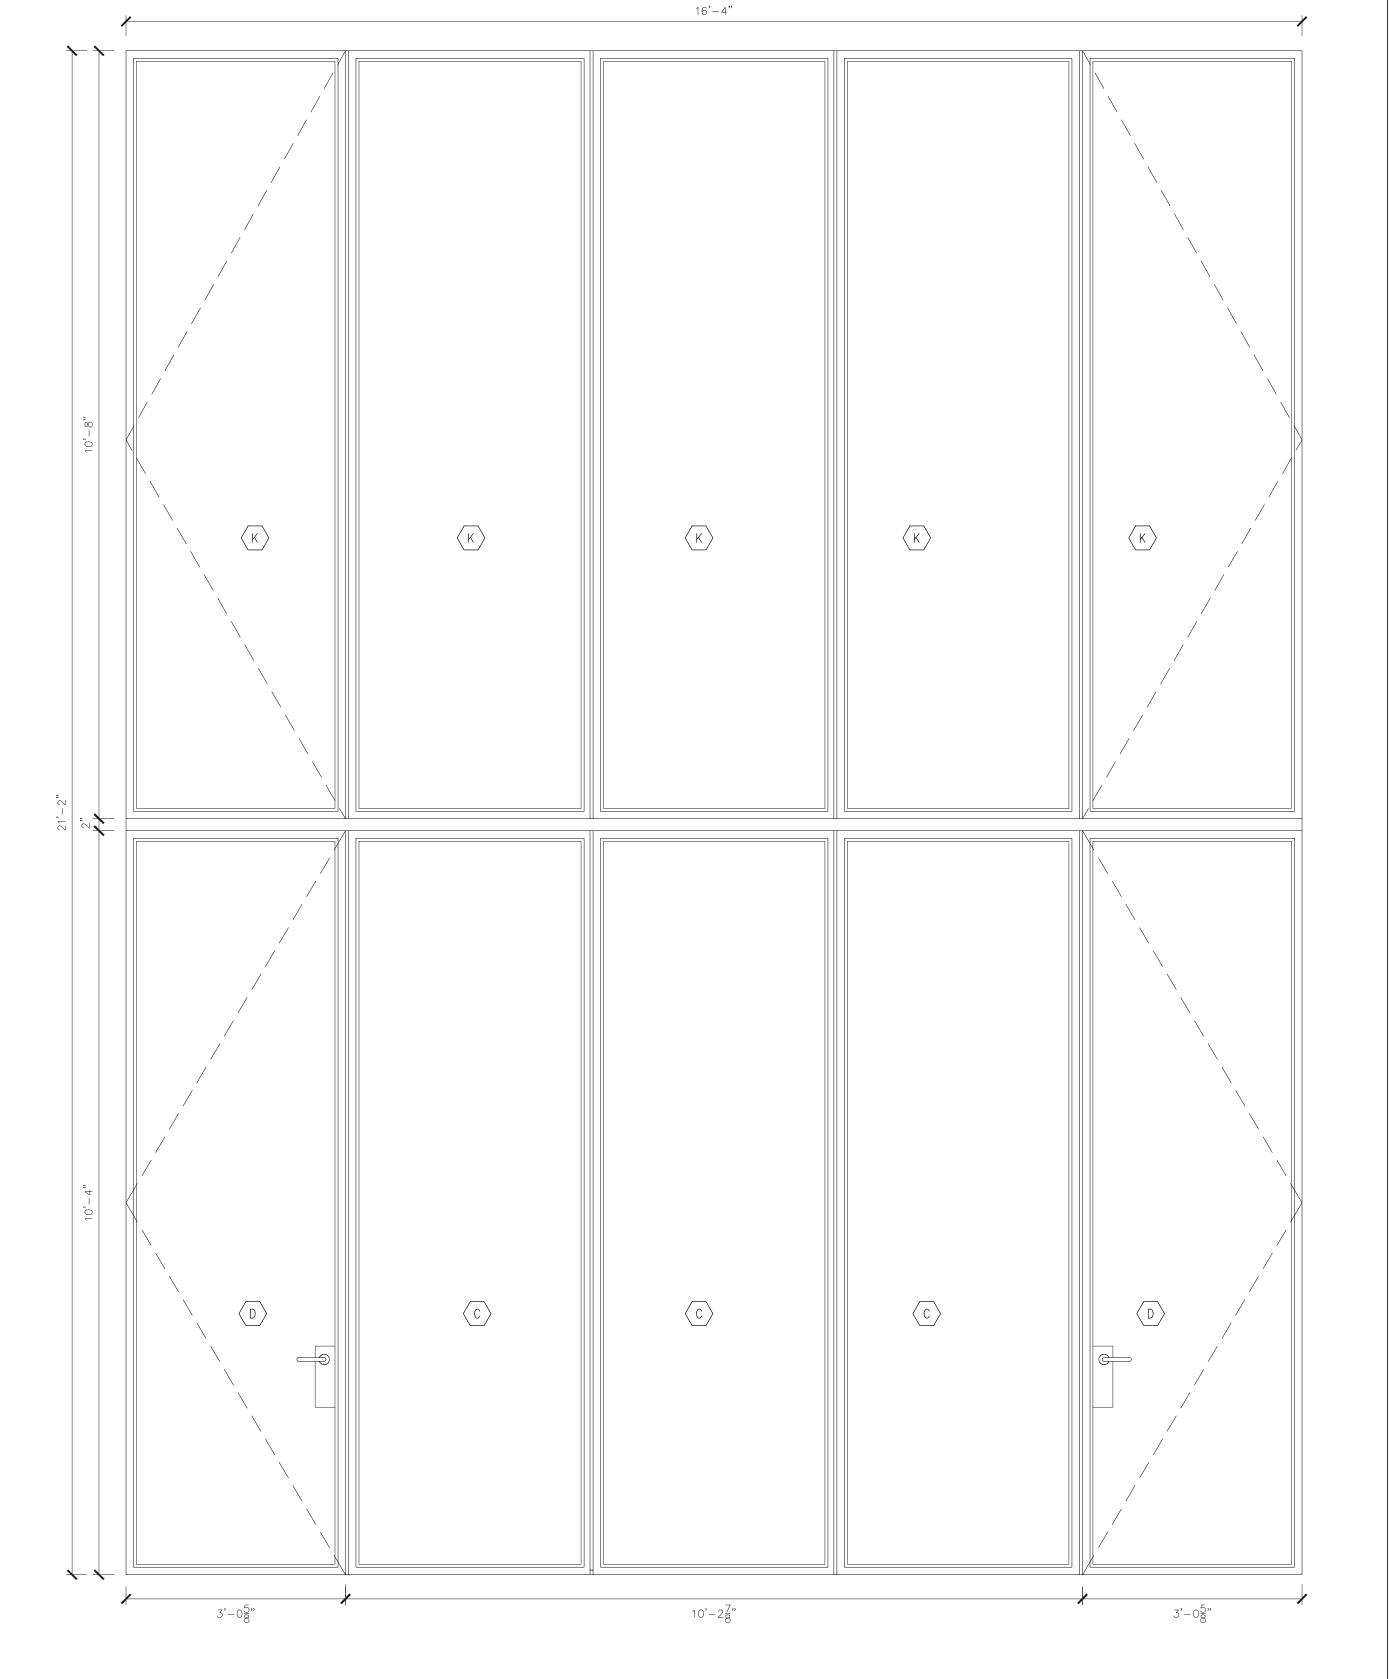
WINDOW SCHEDULE DATE: 10.05.2018

LI Residence 121 W 88TH ST NEW YORK, NY 10024

#	MANUFACTURER	QUANTITY	MODEL	TYPE	ROUGH OPENING (HxW)	GLAZING	HARDWARE REMARKS	U-VALUE	SHGF VALUE
WINDOW									
A	LEPAGE	2		DOUBLE HUNG	2'10" X 4'11"	1	WOOD (STYLE TO MATCH EXISTING)	0.29	0.29
В	LEPAGE	1 1		GLAZED DOOR	5'4" X 7'	1 1	WOOD (STYLE TO MATCH EXISTING)	0.3	0.24
C	OPTIMUM WINDOW	1 1		FIXED	9' 3 1/4" X 10' 5 1/2"	2	STEEL	0.35	0.4
D	OPTIMUM WINDOW	2		GLAZED DOOR	3' 0 5/8" X 10' 5 1/2"	2	STEEL	0.35	0.4
Е	LEPAGE	1		DOUBLE HUNG	3'4 X 7'2"	1	WOOD (STYLE TO MATCH EXISTING)	0.29	0.29
F	LEPAGE	2		DOUBLE HUNG	2'10" X 7'2"	1	WOOD (STYLE TO MATCH EXISTING)	0.29	0.29
G	OPTIMUM WINDOW	2		CASEMENT	3'-0 5/8" X 10' - 8"	2	STEEL	0.35	0.4
I	LEPAGE	1		DOUBLE HUNG	3'4" X 6' 8"	1	WOOD (STYLE TO MATCH EXISTING)	0.29	0.29
J	LEPAGE	2		DOUBLE HUNG	2' 10" X 6' 8"	1	WOOD (STYLE TO MATCH EXISTING)	0.29	0.29
K	OPTIMUM WINDOW	1		FIXED	10' 2 7/8" X 10' 8"	2	STEEL	0.35	0.4
L	LEPAGE	1		DOUBLE HUNG	3' - 4" X 5' - 9"	1	WOOD (STYLE TO MATCH EXISTING)	0.29	0.29
М	LEPAGE	2		DOUBLE HUNG	2' -10" X 5' - 9"	1	WOOD (STYLE TO MATCH EXISTING)	0.29	0.29
N	OPTIMUM WINDOW	3		CASEMENT	3' -6" X 6' - 8"	2	STEEL	0.35	0.4
0	OPTIMUM WINDOW	4		FIXED	14' - 4 7/8" X 8' - 9 1/4"	2	STEEL	0.35	0.4
Р	OPTIMUM WINDOW	1		GLAZED DOOR	3'- 7 1/8" X 8' - 9 1/4"	2	STEEL	0.35	0.4
Q	OPTIMUM WINDOW	1		FIXED	18' - 0 " X 4' - 1 1/4"	2	STEEL	0.35	0.4
S	OPTIMUM WINDOW	1		GLAZED DOOR	3' 6" X 7' 1 3/8"	2	STEEL	0.35	0.4
Т	OPTIMUM WINDOW	2		CASEMENT	3' 6" X 5' 2 7/8"	2	STEEL	0.35	0.4
U	OPTIMUM WINDOW	1		FIXED	8' 11 7/8" X 7' 8 7/8"	2	STEEL	0.35	0.4
V	OPTIMUM WINDOW	2		CASEMENT	3' 0" X 7' 8 7/8"	2	STEEL	0.35	0.4
HARDWARE 1	OPTIMUM WINDOW						OPTIMUM WINDOW SUPPLIED HARDWARE		
2	LEPAGE						LEPAGE SUPPLIED HARDWARE		
	LEI AGE								
GLAZING									
1	CUSTOM						5/8" INSULATED GLASS WITH LOW E FILM GLAZING		
2	CUSTOM						3/8" CLEAR ANNEALED + .062 XIR FILM + 3/8" LOW E ANNEALED (LOW E ON #4 SURFACE)5/8" INSULATED GLASS WITH LOW E FILM GLAZING		
NOTES									
01.									
02.									
03.									

WINDOW SCHEDULE NOT TO SCALE



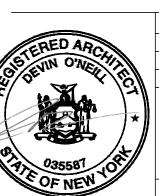


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STEEL WINDOWS AT FIRST THROUGH FOURTH FLOOR

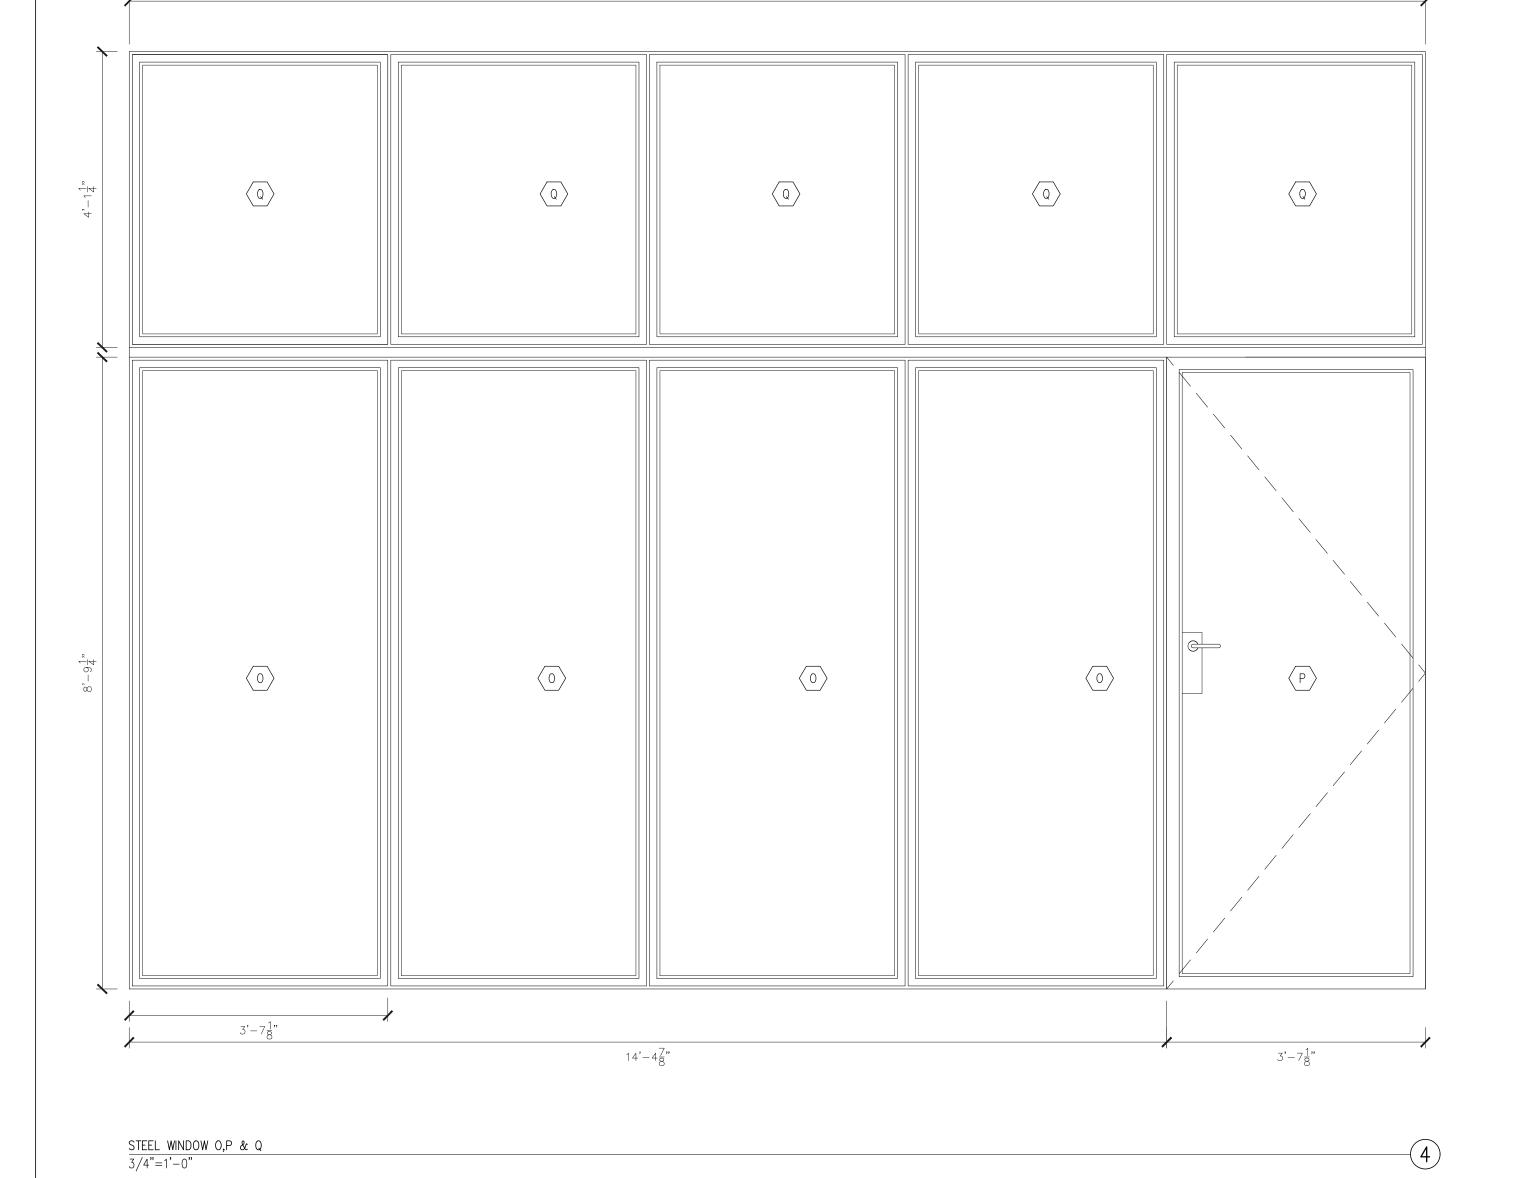


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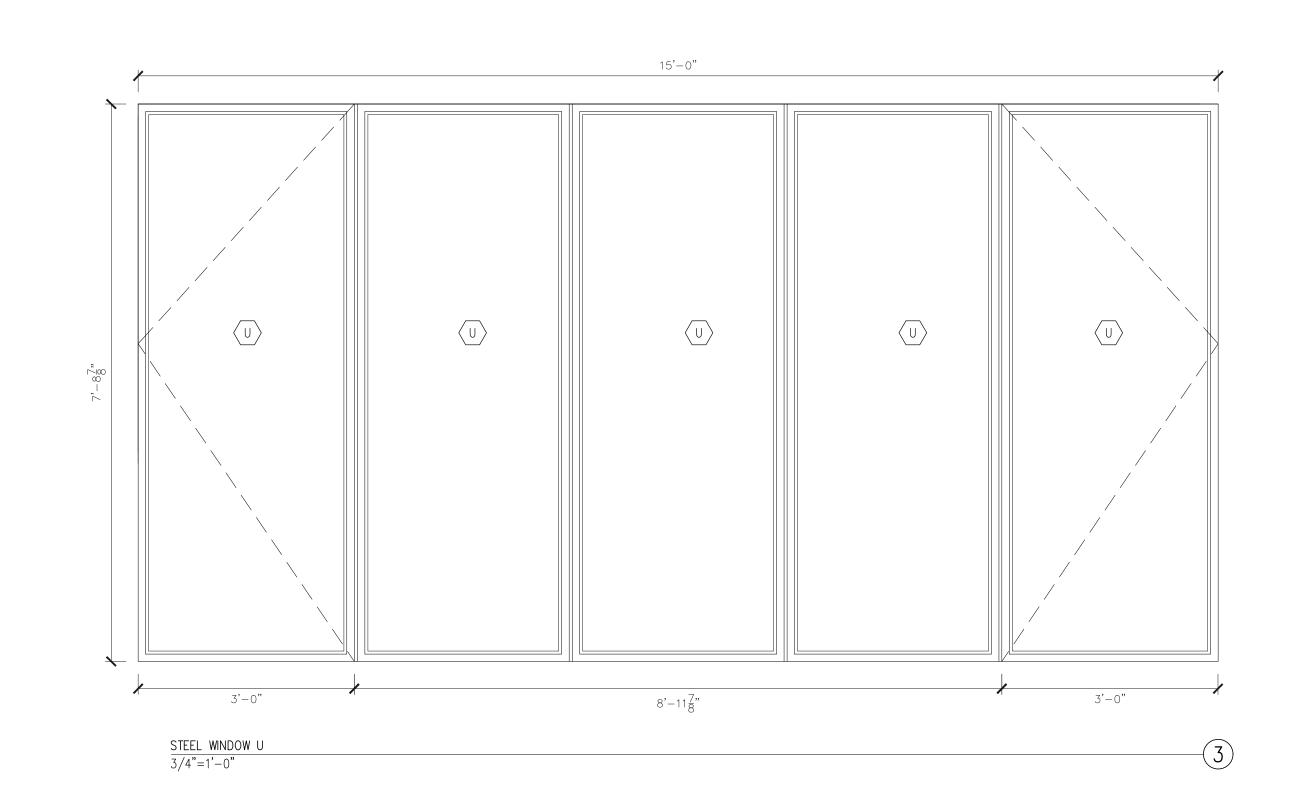
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STEEL WINDOW C,D,G & K 3/4"=1'-0"

NOTE: ALL NEW STEEL WINDOW TO HAVE U VALUE=0.35 & SHGC = 0.4



18'-0"



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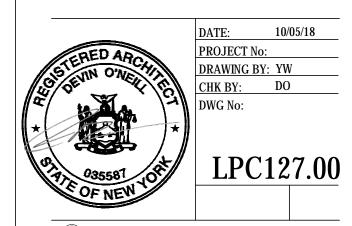
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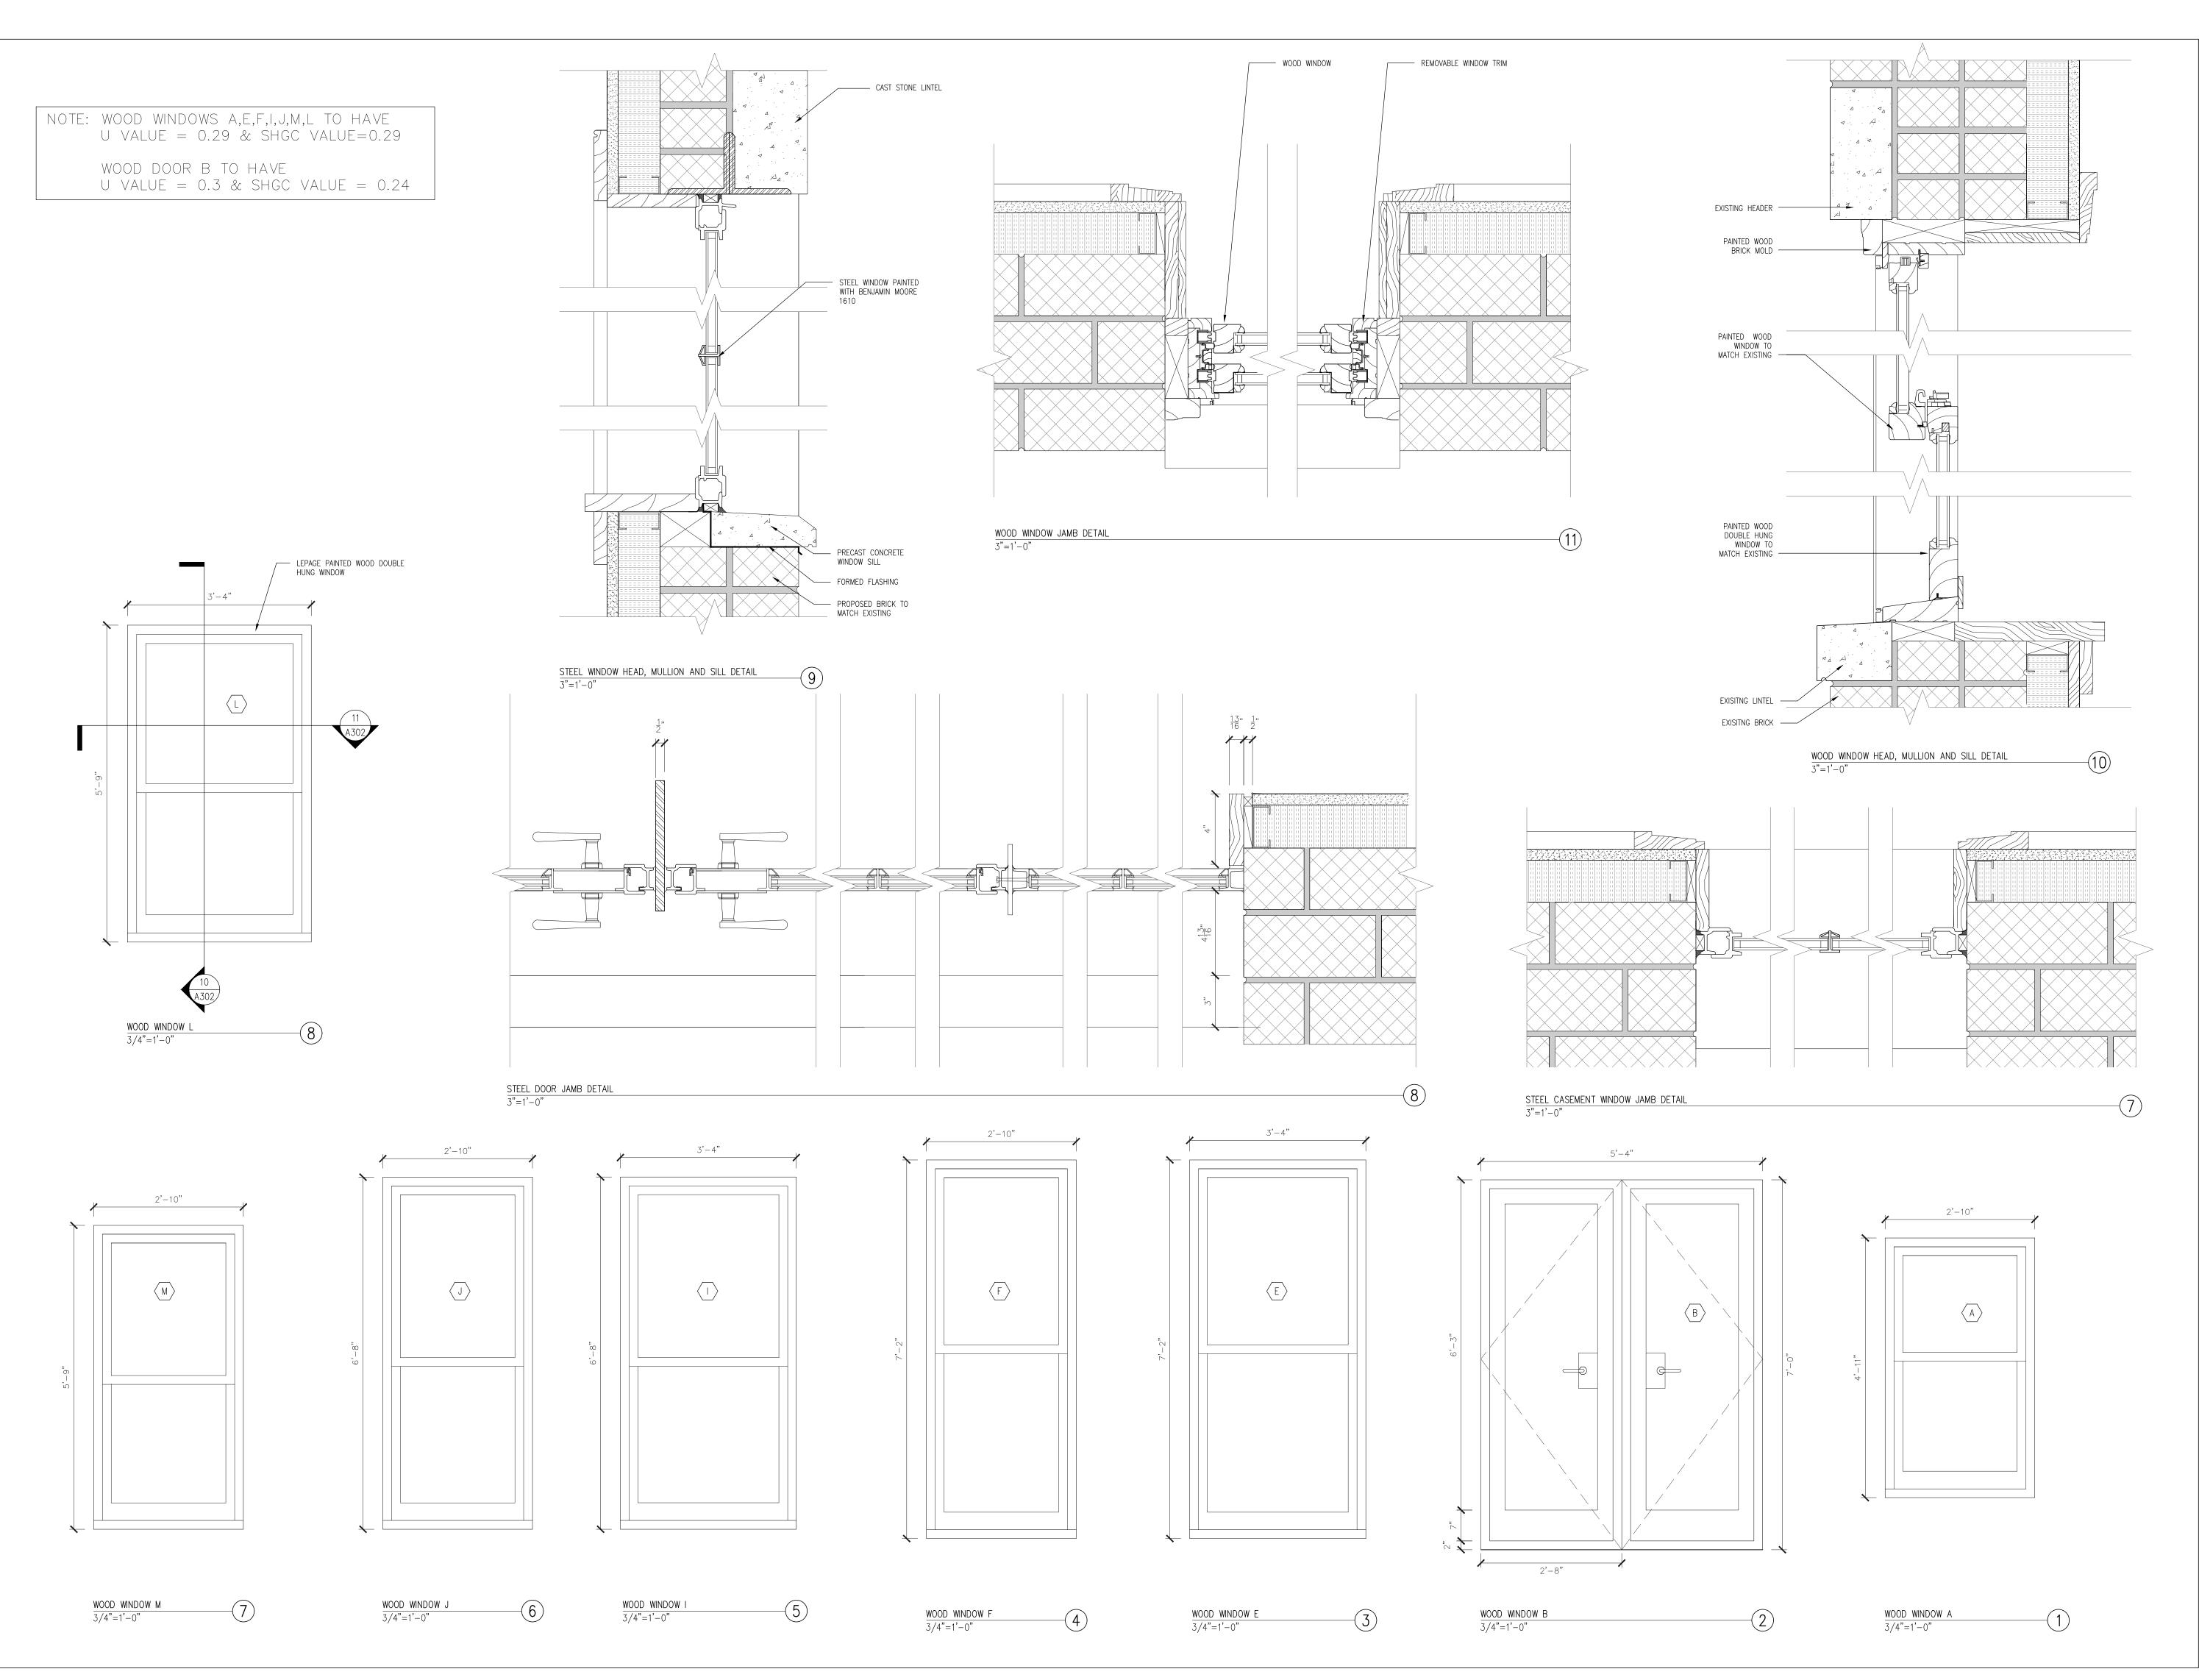
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STEEL WINDOWS AT FIFTH FLOOR



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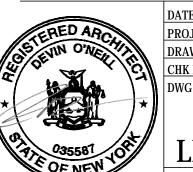
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WOOD WINDOWS AND STEEL/WOOD WINDOW DETAILS



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WALL DETAIL AT FRONT EXTERIOR WALL & ROOF TERRACE

DATE: 10/05/18
PROJECT No:
DRAWING BY: YW
CHK BY: DO
DWG No:

LPC129.00

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- STUCCO FINISH

AT INTERIOR

---- PAINTED GWB

/COLOR TO MATCH PAINTED CEILING

— DENS GLASS GOLD SHEATHING

- STEEL FRAMED WINDOW

W/ INSULATED GLAZING

ROOF DETAIL

1 1/2"=1'-0"

5/8" GYPSUM WALLBOARD

\_ 3/32" MIN. PLASTER WHERE NOTED AS SKIM

TYP. CEILING CONDITION THROUGHOUT

INTERIOR PARTITION TYPES

1 1/2"=1'-0"

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DATE ISSUE

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121 WEST 88TH ST.

- METAL STUDS @ 16" O.C.

SOUND ATTENUATION

BLANKETS

TYP. NEW INTERIOR WALL - PARTITION TYPE 1 (1HR FIRE RATED)

WALL TYPE & ROOF DETAIL

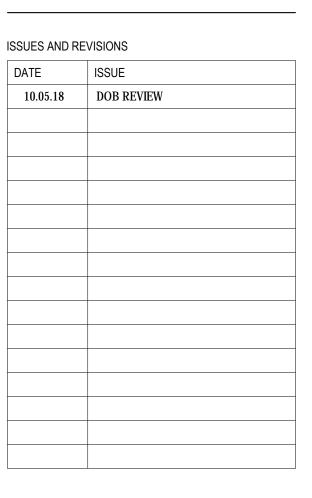
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DRAWING BY: YW
CHK BY: DO
DWG No:

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REAR ADDITION WALL DETAIL

